
BOYNTON YARDS CIVIC SPACE 1

100% CONSTRUCTION DOCUMENTS

LOCUS MAP

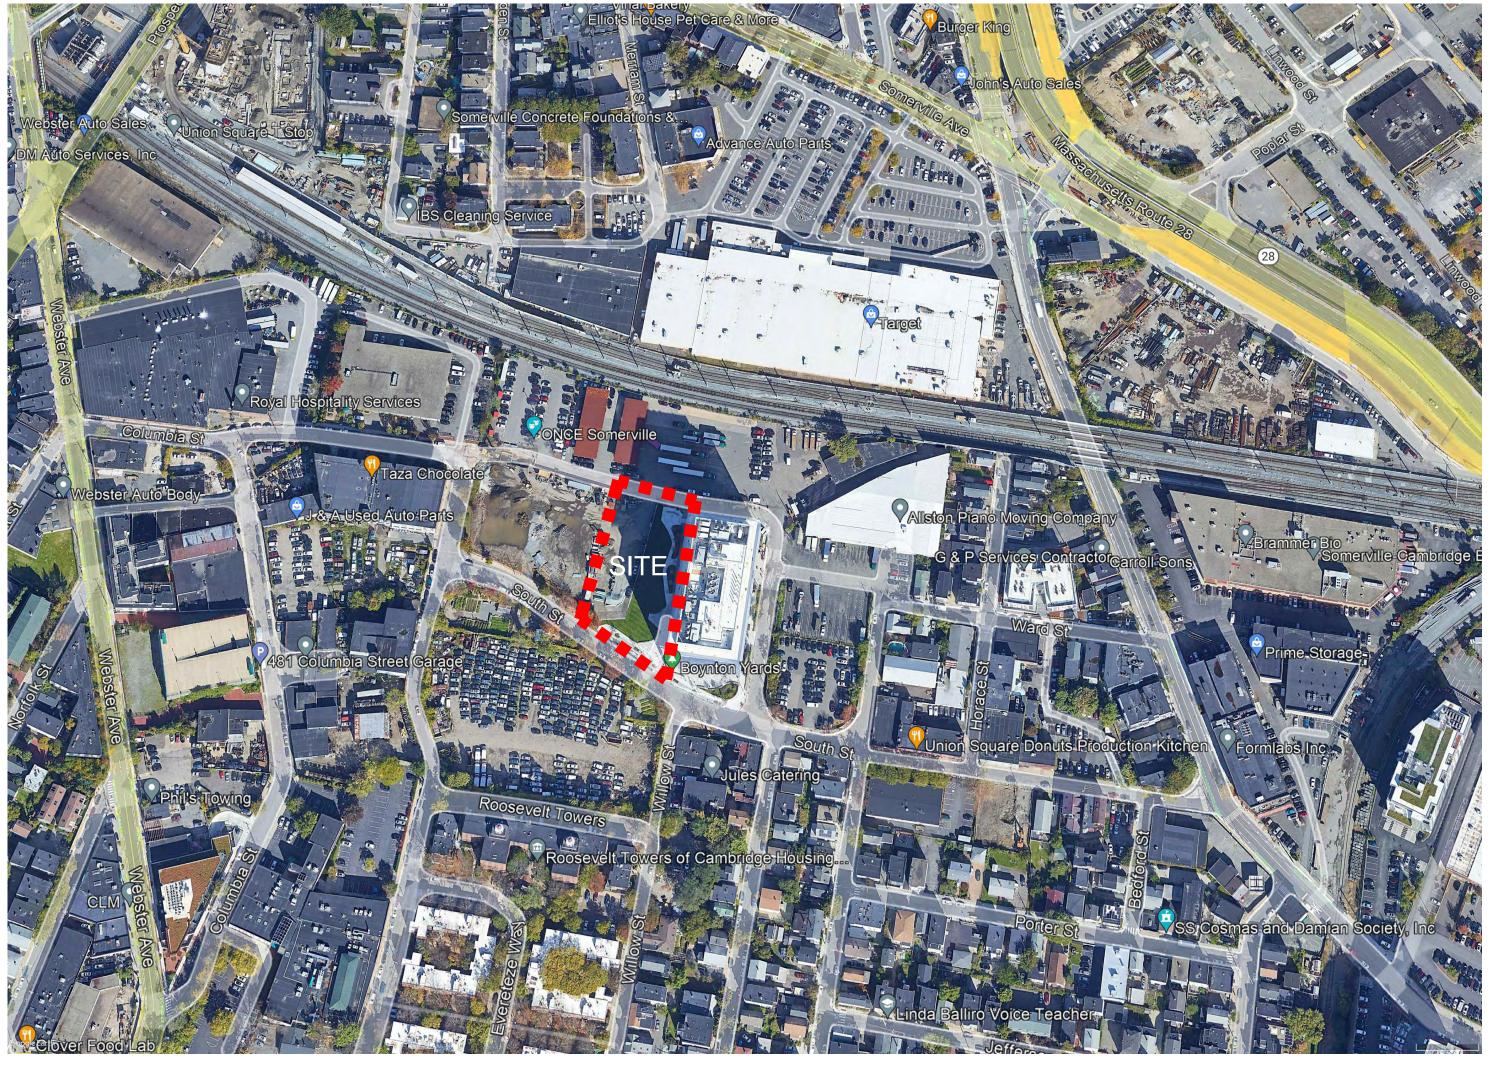

PREPARED BY:

LANDSCAPE ARCHITECT

COPLEY WOLFF DESIGN GROUP 10 POST OFFICE SQUARE, SUITE 1315 BOSTON, MA 02109

IN COLLABORATION WITH:

SURVEYOR

FELDMAN GEOSPATIAL 152 HAMPDEN STREET BOSTON, MA 02119

CIVIL ENGINEER

VANASSE HANGEN BRUSTLIN, LLC. 99 HIGH STREET BOSTON, MA 02110

ELECTRICAL ENGINEER

BR+A CONSULTING ENGINEERS
10 GUEST STREET, 4th FLOOR
BOSTON, MA 02135

IRRIGATION & SPLASH PAD CONSULTANT

AQUEOUS CONSULTANTS
2 DUNDEE PARK DRIVE,
ANDOVER, MA 01810

SITE VIEW





BOYNTON YARDS CIVIC SPACE 1 SHEET INDEX

SHEET#	SHEET TITLE	PREPARED BY
COVER		
EX1.00	EXISTING CONDITIONS PLAN	COPLEY WOLFF DESIGN GROUP
L1.00	SITE PREPARATION PLAN	COPLEY WOLFF DESIGN GROUP
L2.00	MATERIALS PLAN	COPLEY WOLFF DESIGN GROUP
L3.00	LAYOUT PLAN	COPLEY WOLFF DESIGN GROUP
L4.00	GRADING PLAN	COPLEY WOLFF DESIGN GROUP
L5.00	PLANTING PLAN	COPLEY WOLFF DESIGN GROUP
L6.00	LANDSCAPE DETAILS	COPLEY WOLFF DESIGN GROUP
L6.01	LANDSCAPE DETAILS	COPLEY WOLFF DESIGN GROUP
L6.02	LANDSCAPE DETAILS	COPLEY WOLFF DESIGN GROUP
L6.03	LANDSCAPE DETAILS	COPLEY WOLFF DESIGN GROUP
L6.05	CIVIC PLATFORM (FOR REFERENCE ONLY)	COPLEY WOLFF DESIGN GROUP
C1	LEGEND & GENERAL NOTES	VHB
C2	UTILITY PLAN	VHB
C3	UTILITY DETAILS	VHB
E11	ELETRICAL PLAN	BR+A CONSULTING ENGINEERS
E12	PHOTOMETRICS PLAN	BR+A CONSULTING ENGINEERS
E21	ELETRICAL DETAILS	BR+A CONSULTING ENGINEERS
IR1	IRRIGATION PLAN	AQUEOUS CONSULTANTS
IR2	IRRIGATION DETAILS	AQUEOUS CONSULTANTS
IR3	IRRIGATION DETAILS	AQUEOUS CONSULTANTS
IR4	WATER FEATURE LAYOUT PLAN	AQUEOUS CONSULTANTS
IR5	SPLASH PAD DRAINAGE PLAN & SECTION	AQUEOUS CONSULTANTS
IR6	WATER FEATURE DETAILS	AQUEOUS CONSULTANTS
IR7	WATER FEATURE DETAILS	AQUEOUS CONSULTANTS
IR8	WATER FEATURE DETAILS	AQUEOUS CONSULTANTS
IR9	WATER FEATURE DETAILS	AQUEOUS CONSULTANTS

REV# DATE DESCRIPTION

STAMP:

100% CD SET

COVER

DRAWN BY: AML

CHECKED BY: IR

SCALE:

DATE: 03/10/2023

SHEET 1 OF 11

C000

ISSUANCES:

DRAWING TITLE:

DRAWN BY:	RA
CHECKED BY:	JVC
SCALE:	NTS
DATE:	2/40/2/

SHEET 1 OF 3 DRAWING NUMBER:

Legend

Exist.

Prop.

BUILDING SETBACK

---- ZONING LINE

_____ LIMIT OF DISTURBANCE

———— WETLAND LINE WITH FLAG

————BZ———— WETLAND BUFFER ZONE

200' RIVERFRONT AREA

BB BITUMINOUS BERM

EDGE OF PAVEMENT

CONCRETE CURB

EXTRUDED CONCRETE CURB

CURB AND GUTTER

PRECAST CONC. CURB

VGC VERT. GRAN. CURB

LIMIT OF CURB TYPE

BUILDING

BOLLARD

_ — — — SAWCUT

STEEL GUARDRAIL

WOOD GUARDRAIL

TREE LINE

× × WIRE FENCE

_ _ _ _ PATH

→ FENCE

_____ RETAINING WALL

CITTED SILT SOCK / STRAW WATTLE

PARKING COUNT

STOP LINE

CROSSWALK

ACCESSIBLE CURB RAMP

VAN-ACCESSIBLE PARKING

ACCESSIBLE PARKING

COMPACT PARKING STALLS

STOCKADE FENCE

—— · · · — DETENTION BASIN

----4---- 4 — MINOR CONTOUR

——20—— MAJOR CONTOUR

DOUBLE YELLOW LINE

STONE WALL

HAY BALES

CIIIIII .

BITUMINOUS CURB

MONOLITHIC CONCRETE CURB

SLOPED GRAN. EDGING

BUILDING ENTRANCE

LOADING DOCK

DUMPSTER PAD

DOUBLE SIGN

NO DISTURB ZONE

__ _ _ _ _ GRAVEL ROAD

PROJECT LIMIT LINE

RIGHT-OF-WAY/PROPERTY LINE

PARKING SETBACK

— – CONSTRUCTION LAYOUT

TOWN LINE

Exist.

27.35 TC×

132.75 ×

Prop.

FORCE MAIN

——E—— ELECTRIC

TELEPHONE

—— CATV—— CABLE TV

----OHW ---- OHW ---- OVERHEAD WIRE

——2"DW—— DOMESTIC WATER

CONCRETE

RIPRAP

HEAVY DUTY PAVEMENT

CONSTRUCTION EXIT

SPOT ELEVATION

BORING LOCATION

TEST PIT LOCATION

MONITORING WELL

CATCH BASIN CONCENTRIC

CATCH BASIN ECCENTRIC

GUTTER INLET

TRENCH DRAIN

FLARED END SECTION

CURB STOP & BOX

WATER VALVE & BOX

FIRE HYDRANT

WATER METER

WATER WELL

GAS GATE

GAS METER

ELECTRIC MANHOLE

TRANSFORMER PAD

GUY WIRE & ANCHOR

ELECTRIC METER

LIGHT POLE

UTILITY POLE

GUY POLE

HAND HOLE

PULL BOX

MATCHLINE

POST INDICATOR VALVE

PLUG OR CAP

CLEANOUT

HEADWALL

DOUBLE CATCH BASIN CONCENTRIC

DOUBLE CATCH BASIN ECCENTRIC

DRAIN MANHOLE CONCENTRIC

SEWER MANHOLE CONCENTRIC

TAPPING SLEEVE, VALVE & BOX

FIRE DEPARTMENT CONNECTION

SEWER MANHOLE ECCENTRIC

DRAIN MANHOLE ECCENTRIC

TOP OF CURB ELEVATION

BOTTOM OF CURB ELEVATION

TOP & BOTTOM OF WALL ELEVATION

Abbreviations General ABAN ABANDON ACCESSIBLE CURB RAMP ADJUST APPROX APPROXIMATE BITUMINOUS BOTTOM OF SLOPE BWLL BROKEN WHITE LANE LINE DOUBLE YELLOW CENTER LINE ELEVATION ELEVATION EXISTING FOUNDATION FIRST FLOOR ELEVATION GRADE TO DRAIN LANDSCAPE AREA LIMIT OF DISTURBANCE MINIMUM NOT IN CONTRACT NOT TO SCALE PERFORATED PROP PROPOSED REMOVE RETAIN REMOVE AND DISPOSE REMOVE AND RESET SOLID WHITE EDGE LINE SOLID WHITE LANE LINE

> CATCH BASIN CORRUGATED METAL PIPE CLEANOUT DOUBLE CATCH BASIN DRAIN MANHOLE CAST IRON PIPE COND CONDUIT DUCTILE IRON PIPE FLARED END SECTION FORCE MAIN FRAME AND GRATE FRAME AND COVER **GUTTER INLET** GREASE TRAP HIGH DENSITY POLYETHYLENE PIPE HEADWALL HYDRAN' INVERT ELEVATION INVERT ELEVATION LIGHT POLE METAL END SECTION POST INDICATOR VALVE PAVED WATER WAY POLYVINYLCHLORIDE PIPE REINFORCED CONCRETE PIPE RIM ELEVATION RIM ELEVATION SEWER MANHOLE TAPPING SLEEVE, VALVE AND BOX UNDERGROUND

> > UP UTILITY POLE

Notes General

1. CONTRACTOR SHALL NOTIFY "DIG-SAFE" (1-888-344-7233) AT LEAST 72 HOURS BEFORE EXCAVATING.

- 2. CONTRACTOR SHALL BE RESPONSIBLE FOR SITE SECURITY AND JOB SAFETY. CONSTRUCTION ACTIVITIES SHALL BE IN ACCORDANCE WITH OSHA STANDARDS AND LOCAL REQUIREMENTS.
- ACCESSIBLE ROUTES, PARKING SPACES, RAMPS, SIDEWALKS AND WALKWAYS SHALL BE CONSTRUCTED IN CONFORMANCE WITH THE FEDERAL AMERICANS WITH DISABILITIES ACT AND WITH STATE AND LOCAL LAWS AND REGULATIONS (WHICHEVER ARE MORE STRINGENT).
- 4. AREAS DISTURBED DURING CONSTRUCTION AND NOT RESTORED WITH IMPERVIOUS SURFACES (BUILDINGS, PAVEMENTS, WALKS, ETC.) SHALL RECEIVE 6 INCHES LOAM AND SEED.
- WITHIN THE LIMITS OF THE BUILDING FOOTPRINT, THE SITE CONTRACTOR SHALL PERFORM EARTHWORK OPERATIONS REQUIRED UP TO SUBGRADE ELEVATIONS.
- 6. WORK WITHIN THE LOCAL RIGHTS-OF-WAY SHALL CONFORM TO LOCAL MUNICIPAL STANDARDS. WORK WITHIN STATE RIGHTS-OF-WAY SHALL CONFORM TO THE LATEST EDITION OF THE STATE HIGHWAY DEPARTMENTS STANDARD SPECIFICATIONS FOR HIGHWAYS AND BRIDGES.
- . UPON AWARD OF CONTRACT, CONTRACTOR SHALL MAKE NECESSARY CONSTRUCTION NOTIFICATIONS AND APPLY FOR AND OBTAIN NECESSARY PERMITS, PAY FEES, AND POST BONDS ASSOCIATED WITH THE WORK INDICATED ON THE DRAWINGS, IN THE SPECIFICATIONS, AND IN THE CONTRACT DOCUMENTS. DO NOT CLOSE OR OBSTRUCT ROADWAYS, SIDEWALKS, AND FIRE HYDRANTS, WITHOUT APPROPRIATE PERMITS.
- 8. TRAFFIC SIGNAGE AND PAVEMENT MARKINGS SHALL CONFORM TO THE MANUAL ON UNIFORM TRAFFIC CONTROL DEVICES.
- 9. AREAS OUTSIDE THE LIMITS OF PROPOSED WORK DISTURBED BY THE CONTRACTOR'S OPERATIONS SHALL BE RESTORED BY THE CONTRACTOR TO THEIR ORIGINAL CONDITION AT THE CONTRACTOR'S
- 10. IN THE EVENT THAT SUSPECTED CONTAMINATED SOIL, GROUNDWATER, AND OTHER MEDIA ARE ENCOUNTERED DURING EXCAVATION AND CONSTRUCTION ACTIVITIES BASED ON VISUAL, OLFACTORY, OR OTHER EVIDENCE, THE CONTRACTOR SHALL STOP WORK IN THE VICINITY OF THE SUSPECT MATERIAL TO AVOID FURTHER SPREADING OF THE MATERIAL AND SHALL NOTIFY THE OWNER IMMEDIATELY SO THAT THE APPROPRIATE TESTING AND SUBSEQUENT ACTION CAN BE TAKEN.
- 11. CONTRACTOR SHALL PREVENT DUST, SEDIMENT, AND DEBRIS FROM EXITING THE SITE AND SHALL BE RESPONSIBLE FOR CLEANUP, REPAIRS AND CORRECTIVE ACTION IF SUCH OCCURS.
- 12. DAMAGE RESULTING FROM CONSTRUCTION LOADS SHALL BE REPAIRED BY THE CONTRACTOR AT NO ADDITIONAL COST TO OWNER.
- 13. CONTRACTOR SHALL CONTROL STORMWATER RUNOFF DURING CONSTRUCTION TO PREVENT ADVERSE IMPACTS TO OFF SITE AREAS, AND SHALL BE RESPONSIBLE TO REPAIR RESULTING DAMAGES, IF ANY, AT NO COST TO OWNER.
- 14. THIS PROJECT DISTURBS MORE THAN ONE ACRE OF LAND AND FALLS WITHIN THE NPDES CONSTRUCTION GENERAL PERMIT (CGP) PROGRAM AND EPA JURISDICTION. PRIOR TO THE START OF CONSTRUCTION CONTRACTOR IS TO FILE A CGP NOTICE OF INTENT WITH THE EPA AND PREPARE A STORMWATER POLLUTION PREVENTION PLAN IN ACCORDANCE WITH THE NPDES REGULATIONS. CONTRACTOR SHALL CONFIRM THE OWNER HAS ALSO FILED A NOTICE OF INTENT WITH THE EPA.

- 1. THE LOCATIONS, SIZES, AND TYPES OF EXISTING UTILITIES ARE SHOWN AS AN APPROXIMATE REPRESENTATION ONLY. THE OWNER OR ITS REPRESENTATIVE(S) HAVE NOT INDEPENDENTLY VERIFIED THIS INFORMATION AS SHOWN ON THE PLANS. THE UTILITY INFORMATION SHOWN DOES NOT GUARANTEE THE ACTUAL EXISTENCE, SERVICEABILITY, OR OTHER DATA CONCERNING THE UTILITIES, NOR DOES IT GUARANTEE AGAINST THE POSSIBILITY THAT ADDITIONAL UTILITIES MAY BE PRESENT THAT ARE NOT SHOWN ON THE PLANS. PRIOR TO ORDERING MATERIALS AND BEGINNING CONSTRUCTION, THE CONTRACTOR SHALL VERIFY AND DETERMINE THE EXACT LOCATIONS, SIZES, AND ELEVATIONS OF THE POINTS OF CONNECTIONS TO EXISTING UTILITIES AND, SHALL CONFIRM THAT THERE ARE NO INTERFERENCES WITH EXISTING UTILITIES AND THE PROPOSED UTILITY ROUTES, INCLUDING ROUTES WITHIN THE PUBLIC RIGHTS OF WAY.
- WHERE AN EXISTING UTILITY IS FOUND TO CONFLICT WITH THE PROPOSED WORK, OR EXISTING CONDITIONS DIFFER FROM THOSE SHOWN SUCH THAT THE WORK CANNOT BE COMPLETED AS INTENDED, THE LOCATION, ELEVATION, AND SIZE OF THE UTILITY SHALL BE ACCURATELY DETERMINED WITHOUT DELAY BY THE CONTRACTOR, AND THE INFORMATION FURNISHED IN WRITING TO THE OWNER'S REPRESENTATIVE FOR THE RESOLUTION OF THE CONFLICT AND CONTRACTOR'S FAILURE TO NOTIFY PRIOR TO PERFORMING ADDITIONAL WORK RELEASES OWNER FROM OBLIGATIONS FOR ADDITIONAL PAYMENTS WHICH OTHERWISE MAY BE WARRANTED TO RESOLVE THE CONFLICT.
- 3. SET CATCH BASIN RIMS, AND INVERTS OF SEWERS, DRAINS, AND DITCHES IN ACCORDANCE WITH ELEVATIONS ON THE GRADING AND UTILITY PLANS.
- 4. RIM ELEVATIONS FOR DRAIN AND SEWER MANHOLES, WATER VALVE COVERS, GAS GATES, ELECTRIC AND TELEPHONE PULL BOXES, AND MANHOLES, AND OTHER SUCH ITEMS, ARE APPROXIMATE AND SHALL BE SET/RESET AS FOLLOWS:
- A. PAVEMENTS AND CONCRETE SURFACES: FLUSH
- B. ALL SURFACES ALONG ACCESSIBLE ROUTES: FLUSH
- C. LANDSCAPE, LOAM AND SEED, AND OTHER EARTH SURFACE AREAS: ONE INCH ABOVE SURROUNDING AREA AND TAPER EARTH TO THE RIM ELEVATION.
- 5. THE LOCATION, SIZE, DEPTH, AND SPECIFICATIONS FOR CONSTRUCTION OF PROPOSED PRIVATE UTILITY SERVICES SHALL BE INSTALLED ACCORDING TO THE REQUIREMENTS PROVIDED BY, AND APPROVED BY, THE RESPECTIVE UTILITY COMPANY (GAS, TELEPHONE, ELECTRIC, FIRE ALARM, ETC.). FINAL DESIGN LOADS AND LOCATIONS TO BE COORDINATED WITH OWNER AND ARCHITECT.
- 6. CONTRACTOR SHALL MAKE ARRANGEMENTS FOR AND SHALL BE RESPONSIBLE FOR PAYING FEES FOR POLE RELOCATION AND FOR THE ALTERATION AND ADJUSTMENT OF GAS, ELECTRIC, TELEPHONE, FIRE ALARM, AND ANY OTHER PRIVATE UTILITIES, WHETHER WORK IS PERFORMED BY CONTRACTOR OR BY THE UTILITIES COMPANY.
- 7. UTILITY PIPE MATERIALS SHALL BE AS FOLLOWS, UNLESS OTHERWISE NOTED ON THE PLAN:
- A. WATER PIPES SHALL BE COPPER TUBE. B. SANITARY SEWER PIPES SHALL BE POLYVINYL CHLORIDE (PVC) SDR 35 SEWER PIPE.
- C. STORM DRAINAGE PIPES SHALL BE HIGH-DENSITY POLYETHYLENE (HDPE) UNLESS OTHERWISE
- D. PIPE INSTALLATION AND MATERIALS SHALL COMPLY WITH THE STATE PLUMBING CODE WHERE APPLICABLE. CONTRACTOR SHALL COORDINATE WITH LOCAL PLUMBING INSPECTOR PRIOR TO BEGINNING WORK.
- 8. CONTRACTOR SHALL COORDINATE WITH ELECTRICAL CONTRACTOR AND SHALL FURNISH EXCAVATION, INSTALLATION, AND BACKFILL OF ELECTRICAL FURNISHED SITEWORK RELATED ITEMS SUCH AS PULL BOXES, CONDUITS, DUCT BANKS, LIGHT POLE BASES, AND CONCRETE PADS. SITE CONTRACTOR SHALL FURNISH CONCRETE ENCASEMENT OF DUCT BANKS IF REQUIRED BY THE UTILITY COMPANY AND AS INDICATED ON THE DRAWINGS.
- 9. CONTRACTOR SHALL EXCAVATE AND BACKFILL TRENCHES FOR GAS IN ACCORDANCE WITH GAS COMPANY'S REQUIREMENTS.
- 10. ALL DRAINAGE AND SANITARY STRUCTURE INTERIOR DIAMETERS (4' MIN.) SHALL BE DETERMINED BY THE MANUFACTURER BASED ON THE PIPE CONFIGURATIONS SHOWN ON THESE PLANS AND LOCAL MUNICIPAL STANDARDS. FOR MANHOLES THAT ARE 20 FEET IN DEPTH AND GREATER, THE MINIMUM DIAMETER SHALL BE 5 FEET.

Demolition

- CONTRACTOR SHALL DISPOSE OF DEMOLITION DEBRIS IN ACCORDANCE WITH APPLICABLE FEDERAL, STATE AND LOCAL REGULATIONS, ORDINANCES AND STATUTES.
- 2. THE DEMOLITION LIMITS DEPICTED IN THE PLANS IS INTENDED TO AID THE CONTRACTOR DURING THE BIDDING AND CONSTRUCTION PROCESS AND IS NOT INTENDED TO DEPICT EACH AND EVERY ELEMENT OF DEMOLITION. THE CONTRACTOR IS RESPONSIBLE FOR IDENTIFYING THE DETAILED SCOPE OF DEMOLITION BEFORE SUBMITTING ITS BID/PROPOSAL TO PERFORM THE WORK AND SHALL MAKE NO CLAIMS AND SEEK NO ADDITIONAL COMPENSATION FOR CHANGED CONDITIONS OR UNFORESEEN OR LATENT SITE CONDITIONS RELATED TO ANY CONDITIONS DISCOVERED DURING EXECUTION OF THE
- 3. UNLESS OTHERWISE SPECIFICALLY PROVIDED ON THE PLANS OR IN THE SPECIFICATIONS, THE ENGINEER HAS NOT PREPARED DESIGNS FOR AND SHALL HAVE NO RESPONSIBILITY FOR THE PRESENCE, DISCOVERY, REMOVAL, ABATEMENT OR DISPOSAL OF HAZARDOUS MATERIALS, TOXIC WASTES OR POLLUTANTS AT THE PROJECT SITE. THE ENGINEER SHALL NOT BE RESPONSIBLE FOR ANY CLAIMS OF LOSS DAMAGE EXPENSE DELAY INITIRY OR DEATH ARISING FROM THE PRESENCE OF HAZARDOLIS MATERIAL AND CONTRACTOR SHALL INDEMNIFY AND HOLD HARMLESS THE ENGINEER FROM ANY CLAIMS MADE IN CONNECTION THEREWITH. MOREOVER, THE ENGINEER SHALL HAVE NO ADMINISTRATIVE OBLIGATIONS OF ANY TYPE WITH REGARD TO ANY CONTRACTOR AMENDMENT INVOLVING THE ISSUES OF PRESENCE, DISCOVERY, REMOVAL, ABATEMENT OR DISPOSAL OF ASBESTOS OR OTHER HAZARDOUS MATERIALS.

1. PRIOR TO STARTING ANY OTHER WORK ON THE SITE, THE CONTRACTOR SHALL NOTIFY APPROPRIATE AGENCIES AND SHALL INSTALL EROSION CONTROL MEASURES AS SHOWN ON THE PLANS AND AS IDENTIFIED IN FEDERAL, STATE, AND LOCAL APPROVAL DOCUMENTS PERTAINING TO THIS PROJECT.

- 2. CONTRACTOR SHALL INSPECT AND MAINTAIN EROSION CONTROL MEASURES ON A WEEKLY BASIS (MINIMUM) OR AS REQUIRED PER THE STORMWATER POLLUTION PREVENTION PLAN (SWPPP). THE CONTRACTOR SHALL ADDRESS DEFICIENCIES AND MAINTENANCE ITEMS WITHIN TWENTY-FOUR HOURS OF INSPECTION. CONTRACTOR SHALL PROPERLY DISPOSE OF SEDIMENT SUCH THAT IT DOES NOT ENCUMBER OTHER DRAINAGE STRUCTURES AND PROTECTED AREAS.
- 3. CONTRACTOR SHALL BE FULLY RESPONSIBLE TO CONTROL CONSTRUCTION SUCH THAT SEDIMENTATION SHALL NOT AFFECT REGULATORY PROTECTED AREAS, WHETHER SUCH SEDIMENTATION IS CAUSED BY WATER, WIND, OR DIRECT DEPOSIT.
- 4. CONTRACTOR SHALL PERFORM CONSTRUCTION SEQUENCING SUCH THAT EARTH MATERIALS ARE EXPOSED FOR A MINIMUM OF TIME BEFORE THEY ARE COVERED, SEEDED, OR OTHERWISE STABILIZED TO PREVENT EROSION.
- 5. UPON COMPLETION OF CONSTRUCTION AND ESTABLISHMENT OF PERMANENT GROUND COVER. CONTRACTOR SHALL REMOVE AND DISPOSE OF EROSION CONTROL MEASURES AND CLEAN SEDIMENT AND DEBRIS FROM ENTIRE DRAINAGE AND SEWER SYSTEMS.

Existing Conditions Information

1. BASE PLAN: THE PROPERTY LINES SHOWN WERE DETERMINED BY AN ACTUAL FIELD SURVEY CONDUCTED BY FELDMAN LAND SURVEYORS AND FROM PLANS OF RECORD. THE TOPOGRAPHY AND PHYSICAL FEATURES ARE BASED ON AN ACTUAL FIELD SURVEY PERFORMED ON THE GROUND BY FELDMAN LAND SURVEYORS. THE EXISTING CONDITIONS PLAN OF LAND COMPILED BY FELDMAN LAND SURVEYORS IS DATED MAY 14, 2019. THE EXISTING CONDITIONS SHOWN HEREIN IS SUPPLEMENTED BY CONSTRUCTION PLANS FOR 101 SOUTH STREET BY VHB, DATED MARCH 2, 2020 AND CONSTRUCTION PLANS FOR BOYNTON YARDS PHASE 1B UTILITIES BY VHB, DATED MARCH 9, 2021.

2. TOPOGRAPHY: ELEVATIONS ARE BASED ON NAVD 88.

Document Use

FEATURES.

THESE PLANS AND CORRESPONDING CADD DOCUMENTS ARE INSTRUMENTS OF PROFESSIONAL SERVICE, AND SHALL NOT BE USED, IN WHOLE OR IN PART, FOR ANY PURPOSE OTHER THAN FOR WHICH IT WAS CREATED WITHOUT THE EXPRESSED, WRITTEN CONSENT OF VHB. ANY UNAUTHORIZED USE, REUSE, MODIFICATION OR ALTERATION, INCLUDING AUTOMATED CONVERSION OF THIS DOCUMENT SHALL BE AT THE USER'S SOLE RISK WITHOUT LIABILITY OR LEGAL EXPOSURE TO VHB.

- 2. CONTRACTOR SHALL NOT RELY SOLELY ON ELECTRONIC VERSIONS OF PLANS, SPECIFICATIONS, AND DATA FILES THAT ARE OBTAINED FROM THE DESIGNERS, BUT SHALL VERIFY LOCATION OF PROJECT FEATURES IN ACCORDANCE WITH THE PAPER COPIES OF THE PLANS AND SPECIFICATIONS THAT ARE SUPPLIED AS PART OF THE CONTRACT DOCUMENTS.
- 3. SYMBOLS AND LEGENDS OF PROJECT FEATURES ARE GRAPHIC REPRESENTATIONS AND ARE NOT NECESSARILY SCALED TO THEIR ACTUAL DIMENSIONS OR LOCATIONS ON THE DRAWINGS. THE CONTRACTOR SHALL REFER TO THE DETAIL SHEET DIMENSIONS, MANUFACTURERS' LITERATURE, SHOP DRAWINGS AND FIELD MEASUREMENTS OF SUPPLIED PRODUCTS FOR LAYOUT OF THE PROJECT



DDO JECT NAME / CL

PREPARED BY:

PROJECT NAME / CLIENT:

PACE

111 SOUTH STREET, SOMERVILLE, MA

CWDG PROJECT NUMBER: 2036

REV # DATE DESCRIPTION

02 05.22.23 ADDENDUM #2

100% CD SET

UTILITY PLAN

DRAWING TITLE:

DRAWN BY: RA

CHECKED BY: JVC

SCALE: 1" = 20'

DATE: 3/10/2023

SHEET 2 OF 3

C-2

PROJECT NAME / CLIENT:

CURB BOX SET TO FINISH GRADE —

TYPE 'K' COPPER

SERVICE LINE


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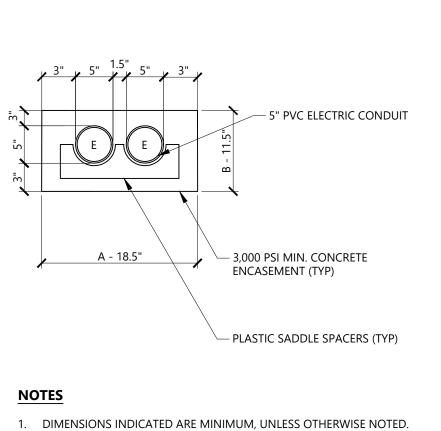
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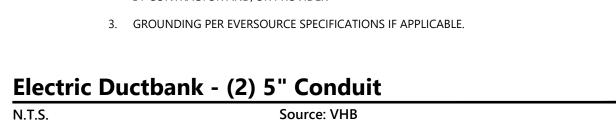
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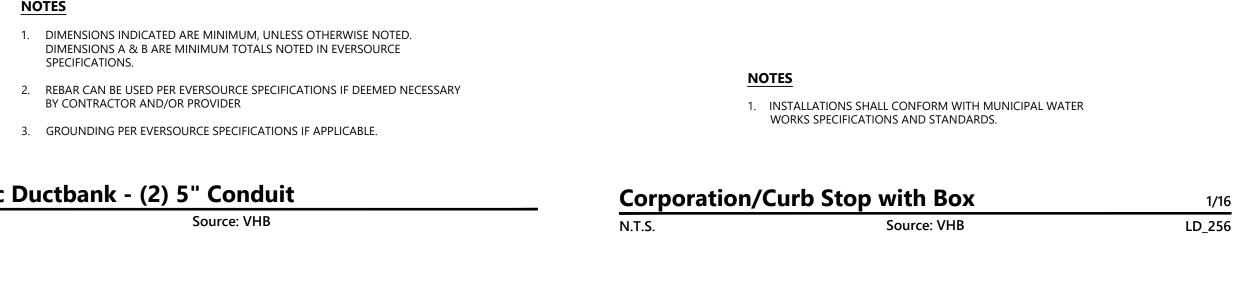
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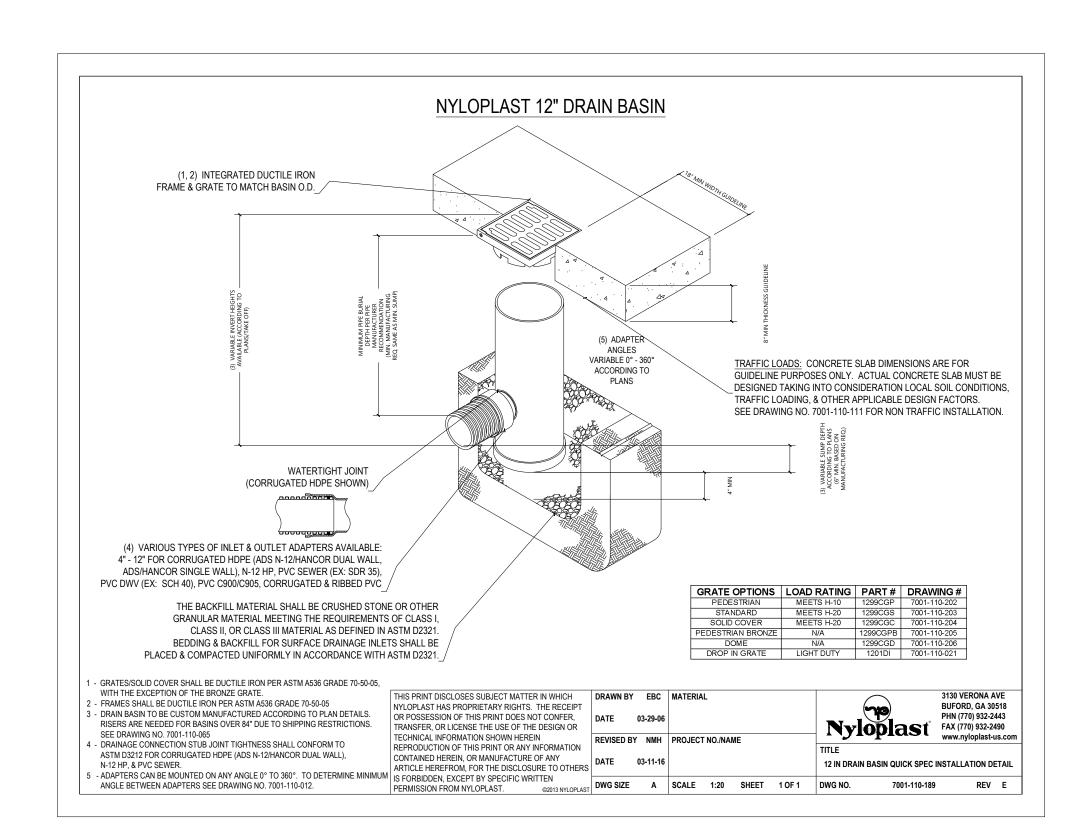


SPECIFICATIONS.




CORPORATION STOP —

WATER MAIN ---

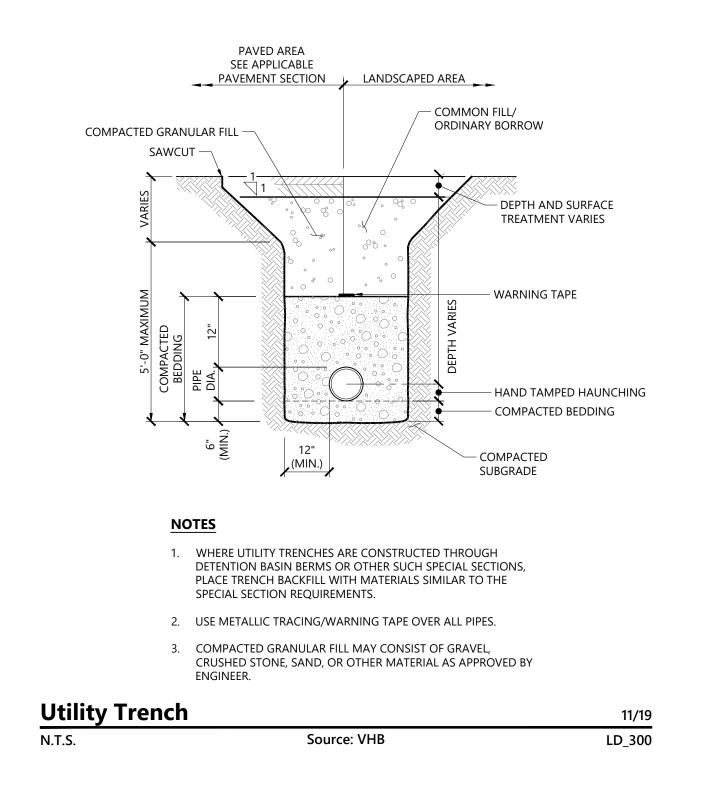

12"	Nyloplast	Area	Drain
N.T.S.			

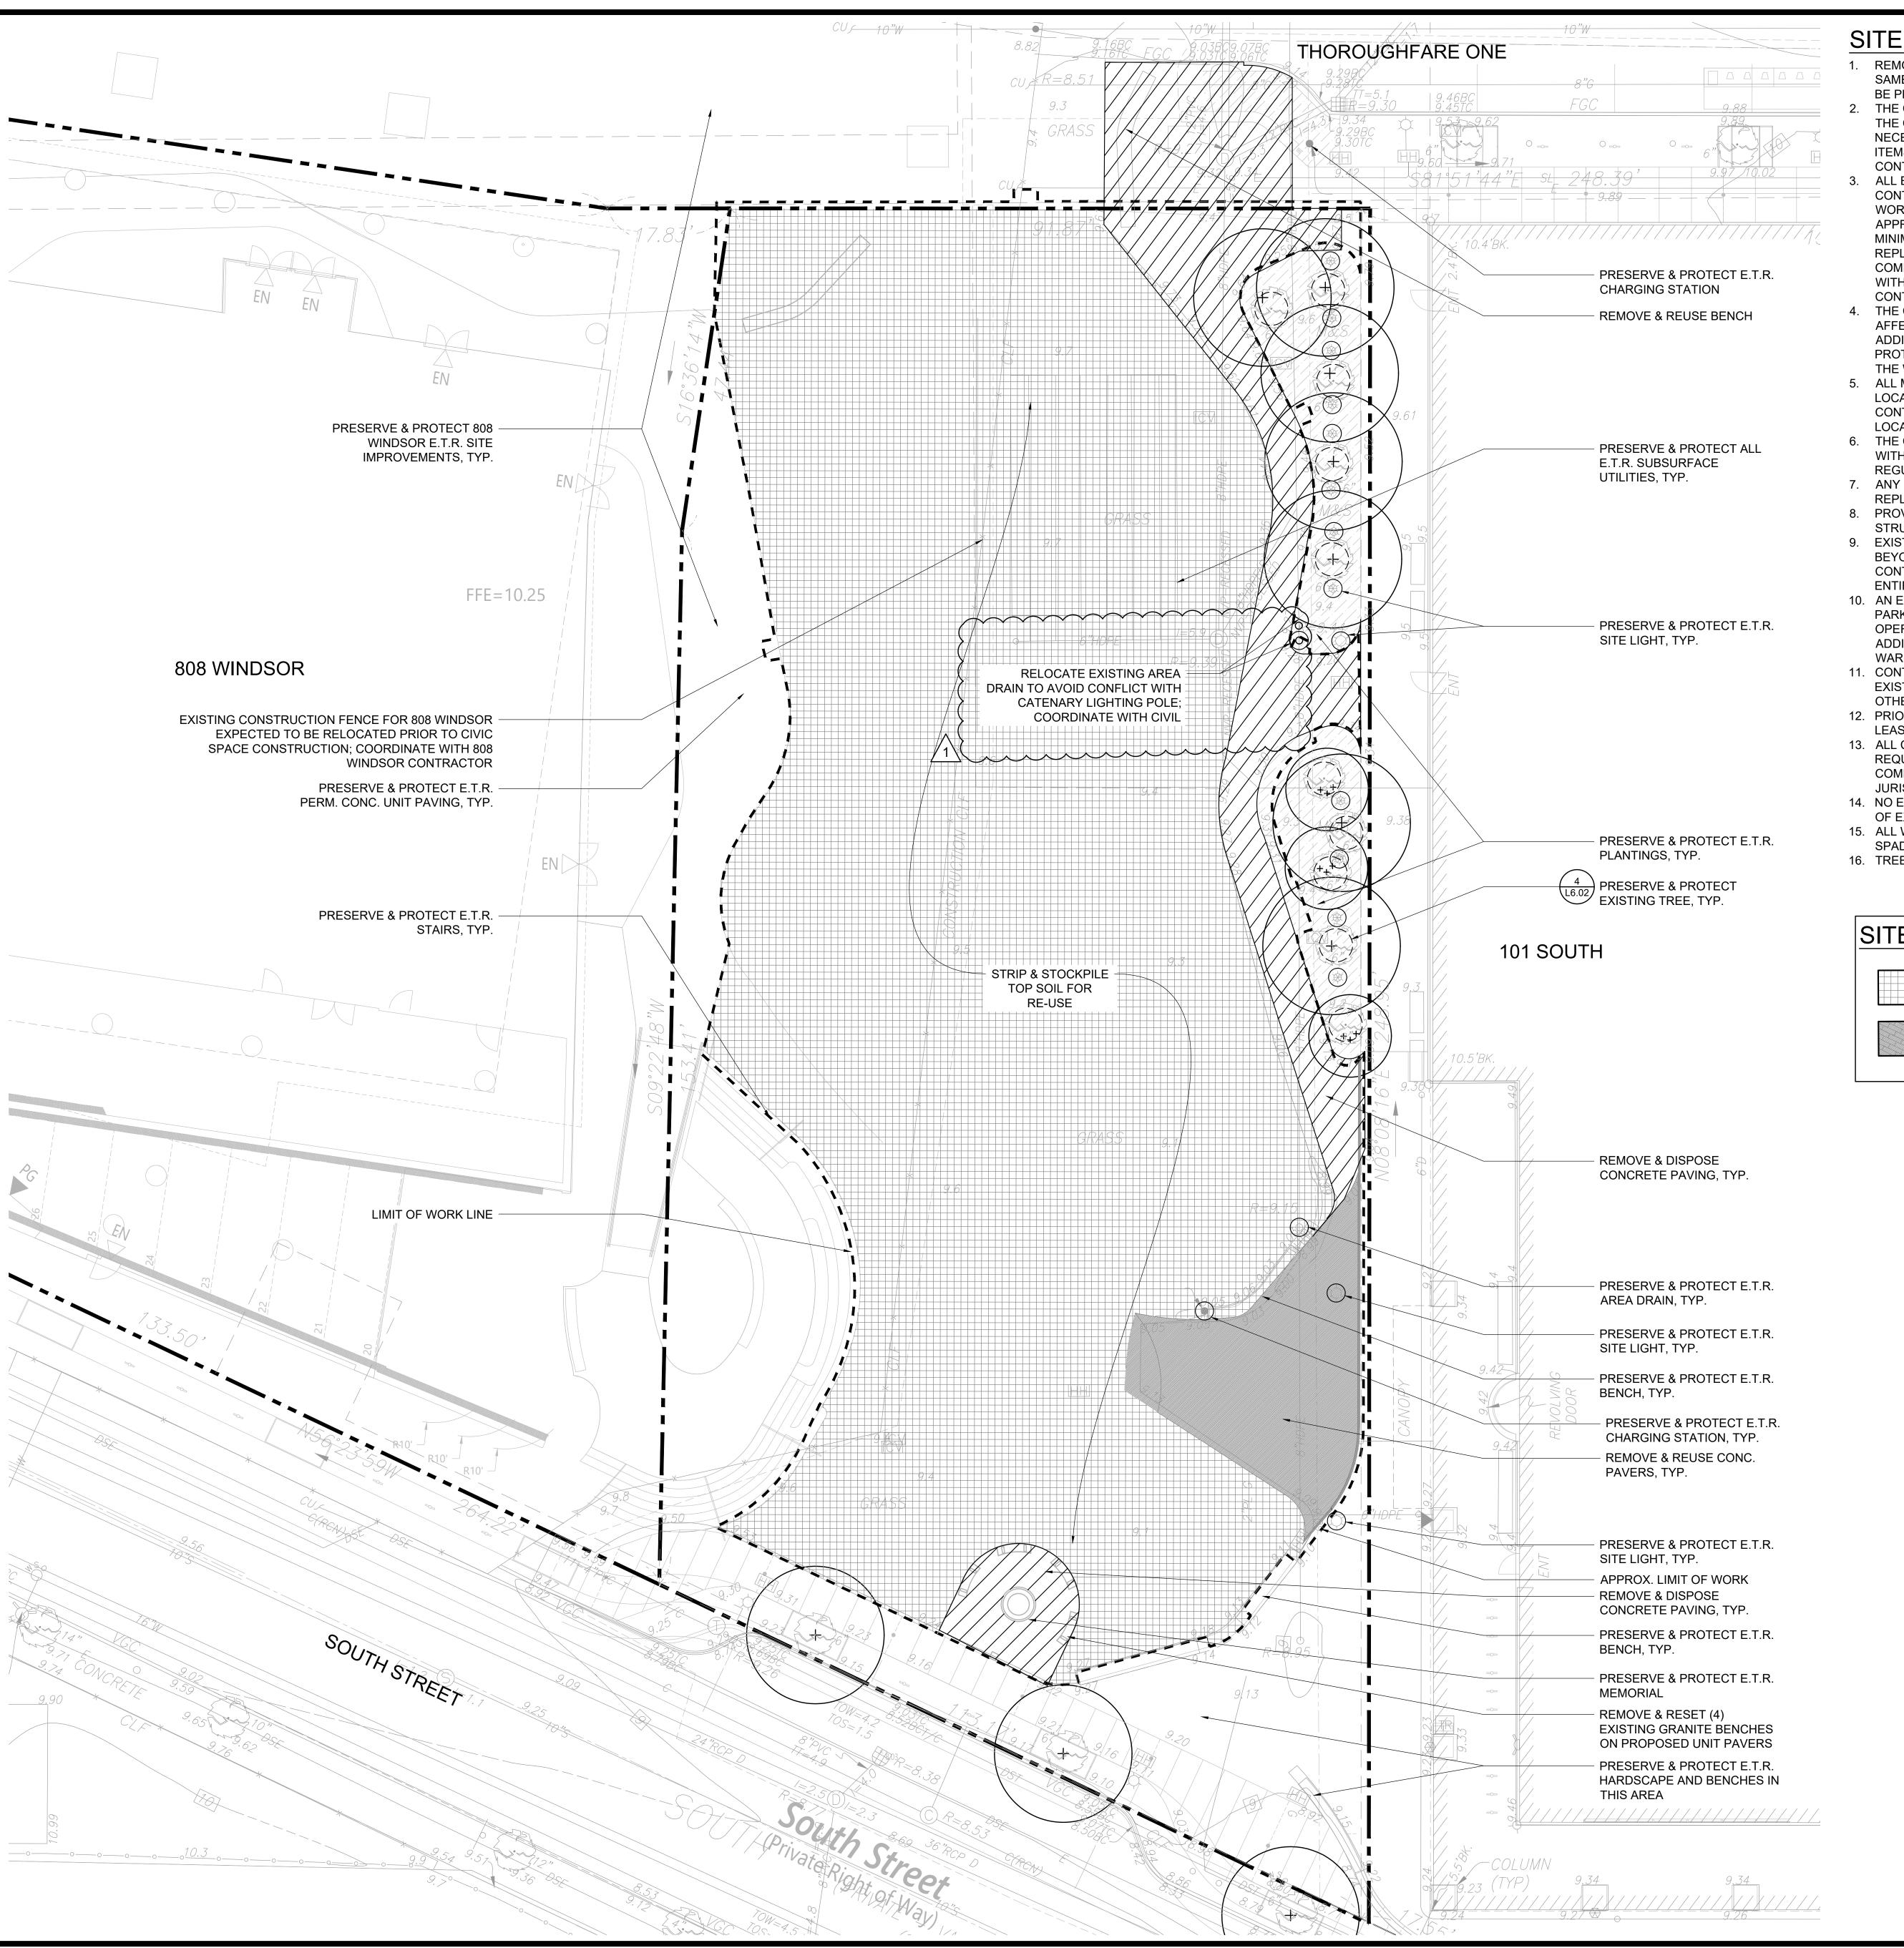


SITE PREPARATION NOTES

- 1. REMOVAL OF ANY WORK OR ITEM SHALL INCLUDE OFFSITE LEGAL DISPOSAL OF SAME, UNLESS OTHERWISE INDICATED. ALL REMOVAL AND DISPOSAL WORK SHALL BE PERFORMED IN A SAFE LEGAL MANNER.
- 2. THE CONTRACTOR SHALL RELOCATE ALL ITEMS SCHEDULED TO REMAIN AWAY FROM THE CONSTRUCTION AREA AND PROTECT AGAINST DUST AND MOISTURE AS NECESSARY. FOLLOWING CONSTRUCTION, THE CONTRACTOR SHALL RETURN THESE ITEMS UNDAMAGED TO THEIR ORIGINAL LOCATIONS. ANY ITEM DAMAGED BY THE CONTRACTOR SHALL BE REPLACED IN KIND AT NO COST TO THE OWNER.
- 3. ALL EXISTING TREES AND SHRUBS SHOWN ARE FOR REFERENCE ONLY. THE CONTRACTOR SHALL REMOVE TREES, SHRUBS, AND OTHER VEGETATION IN THE WORK AREA ONLY AS APPROVED ON THE DRAWINGS OR WITH PRIOR WRITTEN APPROVAL BY THE LANDSCAPE ARCHITECT. EVERY EFFORT SHALL BE MADE TO MINIMIZE THE AMOUNT OF VEGETATION DISTURBED. THE CONTRACTOR SHALL REPLACE ALL DAMAGED VEGETATION TO REMAIN IN KIND FOLLOWING THE COMPLETION OF THE WORK. NEWLY PLANTED TREES SHALL BE IN ACCORDANCE WITH THE PROJECT PLANTING PLANS PRIOR TO THE START OF CONSTRUCTION, THE CONTRACTOR SHALL FIELD VERIFY THE LOCATION OF ALL TREES AND SHRUBS.
- 4. THE CONTRACTOR SHALL RESTORE ALL LANDSCAPING AND HARDSCAPING AFFECTED BY THE DEMOLITION AND CONSTRUCTION ACTIVITIES IN KIND, AT NO ADDITIONAL EXPENSE TO THE OWNER. THE CONTRACTOR SHALL PROVIDE TREE PROTECTION AS SPECIFIED IN THE DETAILS FOR ALL TREES TO BE PRESERVED IN THE WORK AREA.
- 5. ALL MATERIALS STOCKPILED DURING THE WORK SHALL BE PLACED IN A DESIGNATED LOCATION THAT PREVENTS EROSION, SEDIMENTATION AND COMPACTION. THE CONTRACTOR SHALL STOCKPILE MATERIALS IN AN AREA ON-SITE. STOCKPILE LOCATION TO BE APPROVED BY LANDSCAPE ARCHITECT.
- 6. THE CONTRACTOR'S DISPOSAL PRACTICE OF ALL EXCESS MATERIAL SHALL COMPLY WITH ALL FEDERAL, STATE, AND MUNICIPAL WASTE MANAGEMENT LAWS AND REGULATIONS.
- 7. ANY ITEM OR STRUCTURE DAMAGED BEYOND THE LIMITS OF WORK SHALL BE REPLACED IN KIND BY THE CONTRACTOR AT HIS OR HER OWN EXPENSE.
- 8. PROVIDE SHORING OR UNDERPINNING AS NECESSARY TO PROTECT EXISTING STRUCTURES.
- 9. EXISTING STRUCTURES, LANDSCAPING, AND HARDSCAPING ARE PRESENT IN AND BEYOND THE LIMITS OF WORK BUT NOT NECESSARILY SHOWN HEREON. THE CONTRACTOR SHALL PROTECT ALL EXISTING FEATURES IN PLACE DURING THE ENTIRE DURATION OF THE PROJECT.
- 10. AN EROSION CONTROL BARRIER SHALL BE INSTALLED ALONG THE EDGE OF THE PARK PRIOR TO THE COMMENCEMENT OF DEMOLITION OR CONSTRUCTION OPERATIONS. THE EROSION CONTROL LINE AS SHOWN IS A MINIMUM REQUIREMENT, ADDITIONAL EROSION CONTROL MEASURE MAY BE REQUIRED AS CONDITIONS WARRANT.
- 11. CONTRACTOR TO PROTECT EXISTING SIGNS TO REMAIN. ADDITIONALLY, ALL EXISTING LIGHT POLES SHALL BE PROTECTED DURING CONSTRUCTION, UNLESS OTHERWISE NOTED ON THE DRAWINGS.
- 12. PRIOR TO THE START OF CONSTRUCTION, NOTIFY "DIG-SAFE" AT 1-888-344-7233 AT LEAST 72 HOURS PRIOR TO ANY SITE DEMOLITION OR EXCAVATION.
- 13. ALL CONSTRUCTION ACTIVITIES SHALL CONFORM TO STATE AND LOCAL REQUIREMENTS, INCLUDING BUT NOT LIMITED TO THE CITY OF BOSTON, THE COMMONWEALTH OF MASSACHUSETTS, AND ANY OTHER AGENCIES HAVING JURISDICTION.
- 14. NO EQUIPMENT, VEHICLES OR STOCKPILES MAY BE PLACED WITHIN THE DRIPLINES OF EXISTING TREES.

SCALE: 1"=10'

- 15. ALL WORK WITHIN THE DRIPLINES OF TREES TO REMAIN IS TO BE HAND DUG OR AIR
- 16. TREE PROTECTION TO BE INSTALLED BEFORE DEMOLITION COMMENCES.

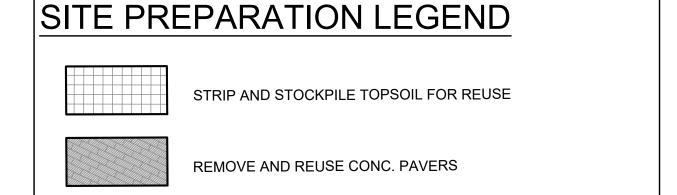

PREPARED BY:

I:\Copley Wolff Logos\CopleyWolff_logo-01.jpg

PROJECT NAME / CLIENT

ON YARDS - CIVIC SPACE

CWDG PROJECT NUMBER: 2036

REV # DATE DESCRIPTION

BO

01 04.26.23 ADDENDUM #1

100% CD SET

SITE PREPARATION PLAN

DRAWN BY:

CHECKED BY:

IR


SCALE:

DATE:

04/26/2023

SHEET 3 OF 11


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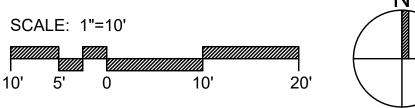
LANDSCAPE MATERIAL NOTES

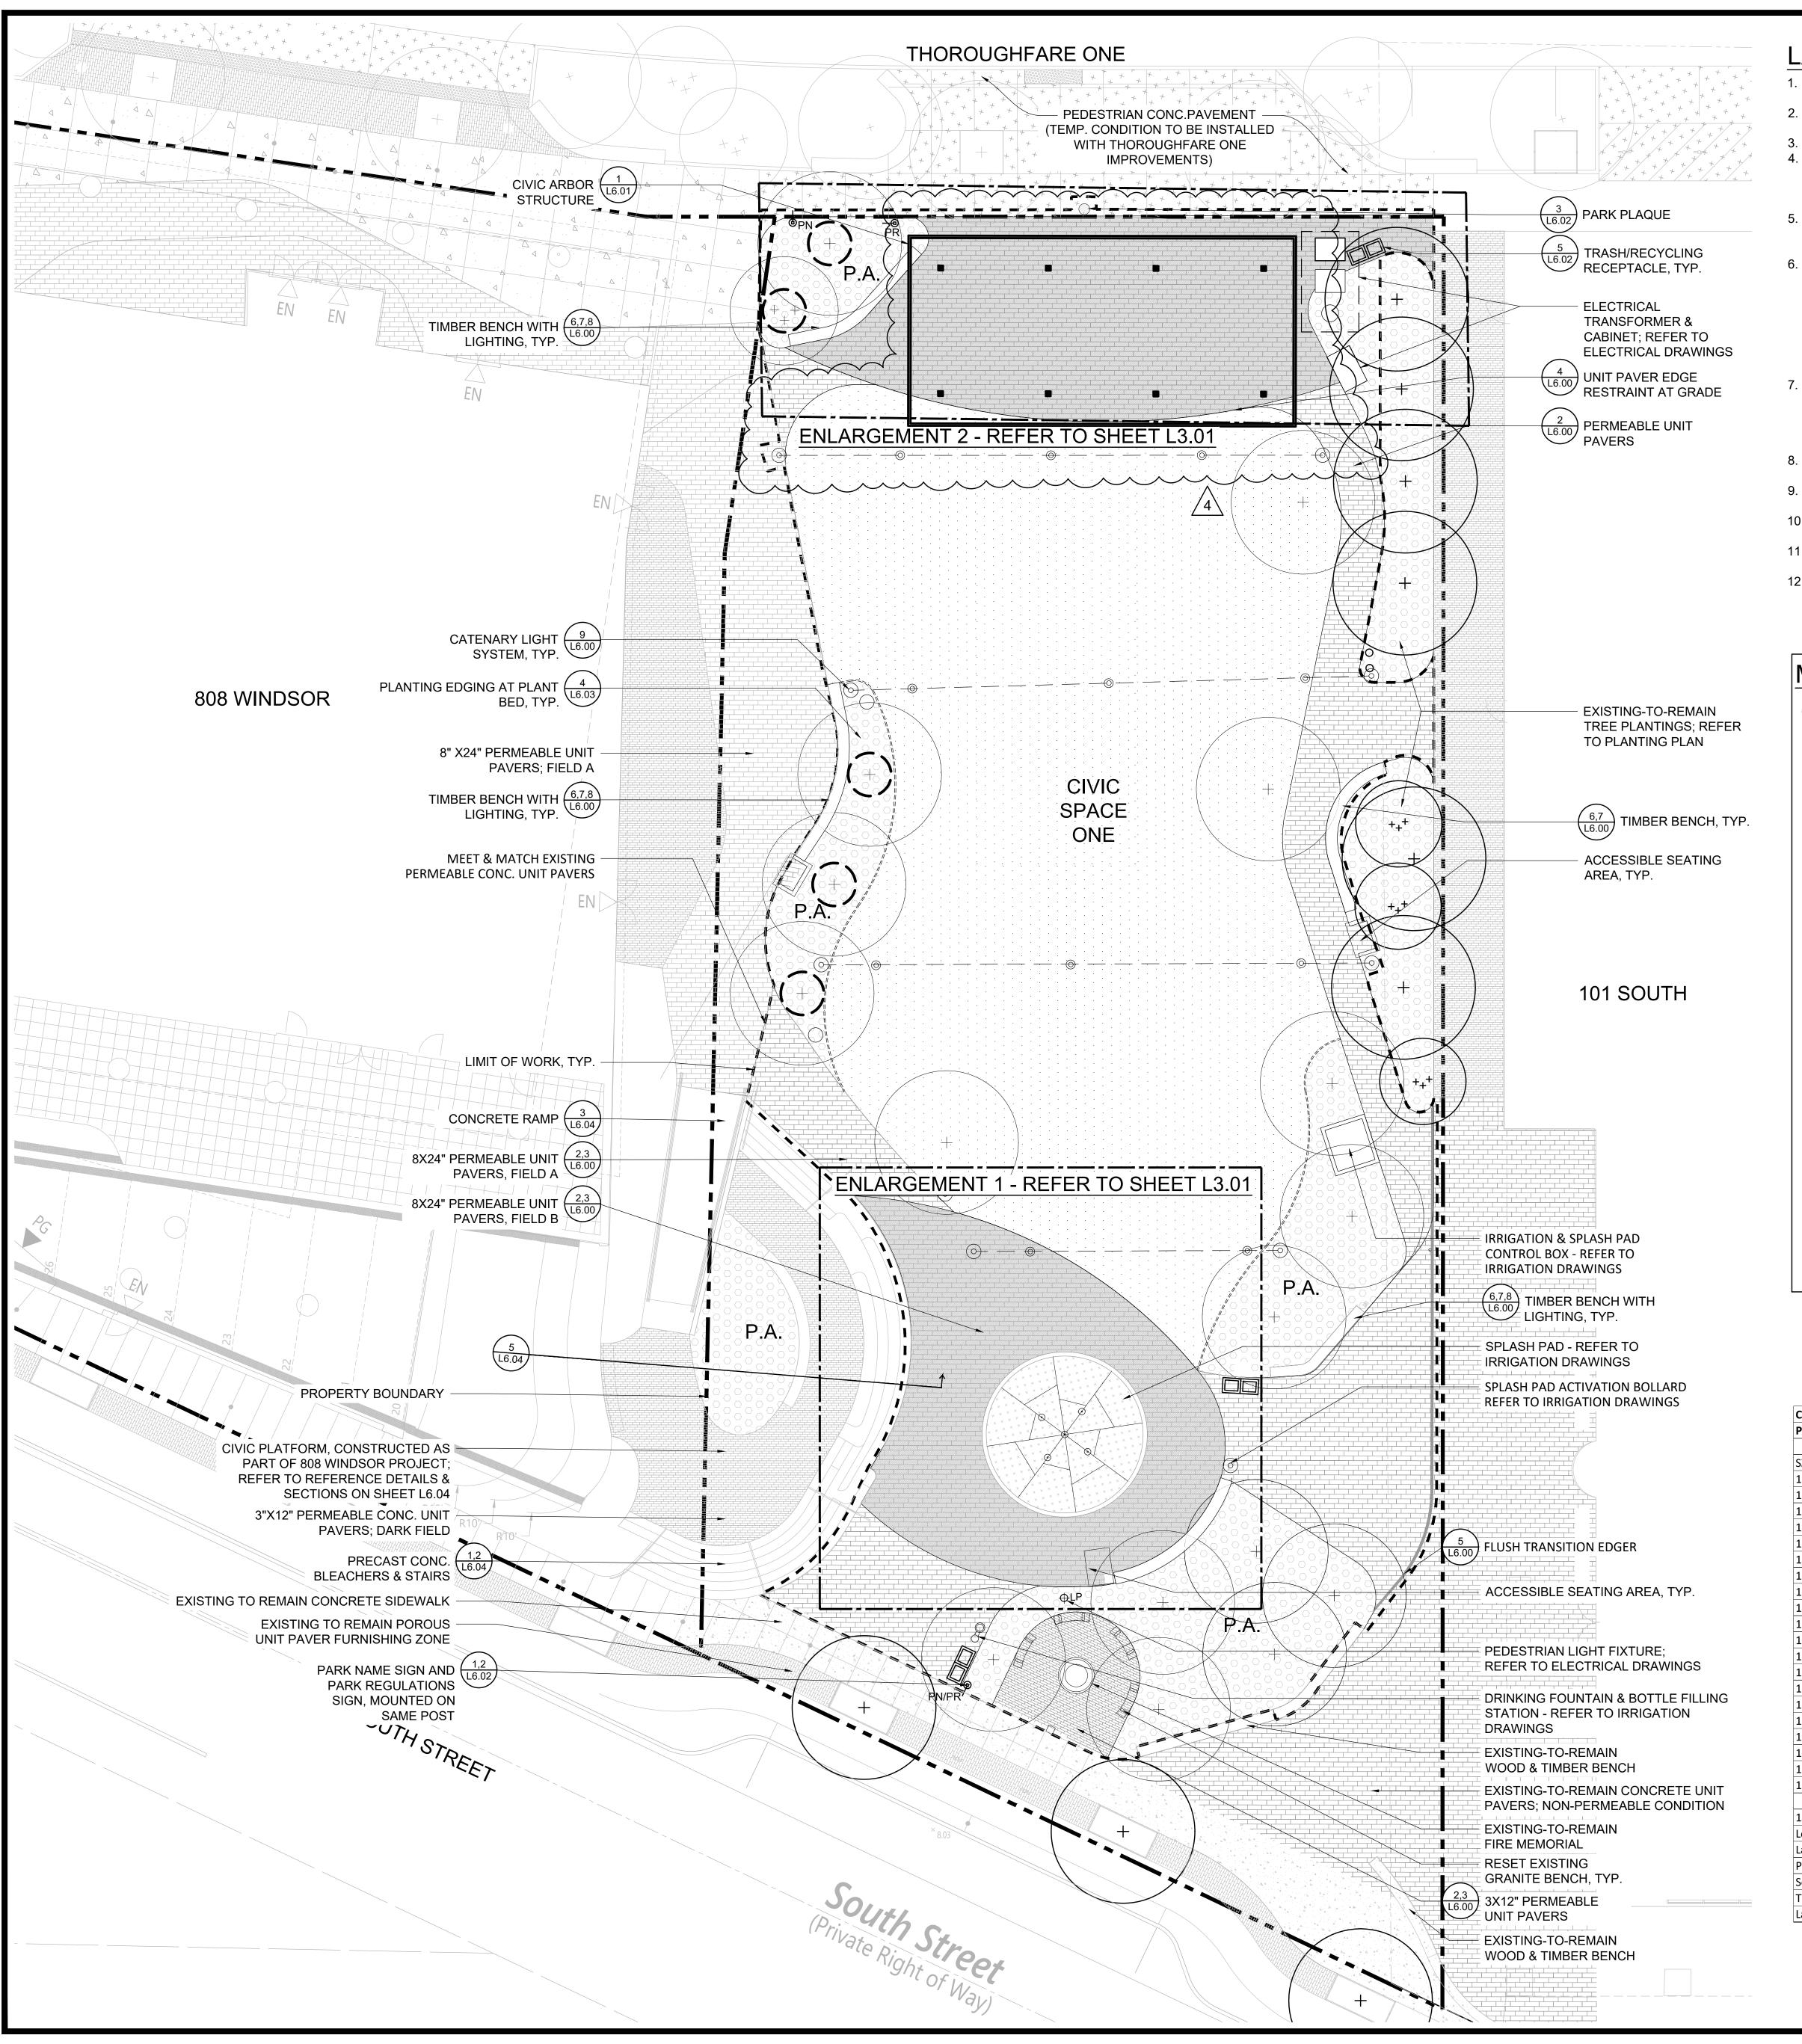- THE CONTRACTOR SHALL REVIEW ALL DRAWINGS AND SPECIFICATIONS TO DETERMINE THE TOTAL SCOPE OF WORK AND ALL REQUIRED COORDINATION.
- 2. THE CONTRACTOR IS RESPONSIBLE FOR A THOROUGH SITE EXAMINATION TO SATISFY HIM OR HERSELF AS TO THE ACTUAL SITE CONDITIONS BEFORE SUBMISSION OF BIDS.
- 3. CONTRACTOR SHALL VERIFY ALL EXISTING UTILITY LOCATIONS PRIOR TO EXCAVATION.

 4. CONTRACTOR SHALL ARRANGE PRE-INSTALLATION CONFERENCES AT PROJECT SITE FOR
- PAVEMENT WORK. ATTENDEES SHALL INCLUDE OWNER'S REPRESENTATIVE, LANDSCAPE ARCHITECT, GENERAL CONTRACTOR AND ALL SUB-CONTRACTORS DIRECTLY CONCERNED WITH THE WORK.
- 5. CONTRACTOR SHALL PREPARE SUBMITTALS TO THE LANDSCAPE ARCHITECT FOR ALL COMPONENTS OF THE FINISHED WORK, INCLUDING SHOP DRAWINGS, PRODUCT DATA, MATERIAL CERTIFICATIONS, MIX DESIGNS AND SAMPLES.
- 6. CONTRACTOR SHALL FURNISH AND INSTALL CONSTRUCTED SAMPLES (MOCK-UPS) DEMONSTRATING ALL COMPONENTS OF THE DESIGN, INCLUDING FINISHED EXPOSED EDGES AND SURFACES, COLORS AND JOINTING FOR REVIEW AND APPROVAL BY THE LANDSCAPE ARCHITECT PRIOR TO CONSTRUCTING FINAL WORK. MOCK-UPS MAY BE PART OF THE FINAL CONSTRUCTION. MOCK-UPS SHALL BE MAINTAINED AND PROTECTED THROUGHOUT THE DURATION OF THE PROJECT AND WILL SERVE AS PROJECT STANDARD. CONTRACTOR SHALL DEMOLISH AND RECONSTRUCT MOCK-UP UNTIL APPROVAL FROM LANDSCAPE ARCHITECT. MOCK-UPS SHALL INCLUDE ONE 6' X 6' PANEL OF EXPOSED AGGREGATE CONCRETE PAVEMENT
- 7. THE DIMENSIONS OF PAVEMENT JOINTS AS SHOWN ON THE DRAWINGS ARE TO THE CENTER LINE OF EACH TYPE OF JOINT EXCEPT WHERE PAVEMENT MEETS A VERTICAL FACE; AT THIS LOCATION DIMENSIONS ARE TO THE VERTICAL FACE. THE DIMENSIONS SHOWN ON DRAWINGS SHOW DESIGN INTENT AND MUST BE FIELD VERIFIED PRIOR TO PREPARATION OF SHOP DRAWINGS. ALL ALIGNMENTS SHALL BE INSTALLED AS SHOWN.
- 8. THE CONTRACTOR SHALL BE RESPONSIBLE FOR DOCUMENTING THE LOCATIONS OF ALL EXISTING SITE ELEMENTS TO BE RESET IN THEIR SAME HORIZONTAL LOCATION.
- 9. THE CONTRACTOR IS RESPONSIBLE FOR ALL DAMAGE INSIDE OR OUTSIDE OF LIMIT OF WORK LINE DUE TO HIS/HER CONSTRUCTION OPERATIONS.
- 10. STORAGE AREAS FOR THE GENERAL CONTRACTOR'S EQUIPMENT AND MATERIALS SHALL BE LOCATED WITHIN THE LIMITS OF WORK AS APPROVED BY THE LANDSCAPE ARCHITECT.
- 11. WHERE NEW PAVING MEETS EXISTING PAVING, MEET LINE AND GRADE OF EXISTING WITH NEW CONSTRUCTION.
- 12. CONTRACTOR SHALL STAKE OR SPRAY OUT EDGES OF ALL HARDSCAPE AND MATERIAL CHANGES IN THE FIELD FOR REVIEW AND APPROVAL THE LANDSCAPE ARCHITECT PRIOR TO THE PLACEMENT OF FINAL EDGING OR FORM WORK.



Park type: Neightbo	orhood	
SZO Requirement	Description	Requirement(s) Met
13.1.2.a	Siting & Orientation	Yes
13.1.2.b	Design & Construction	Yes
13.1.2.c	Accessibility	Yes
13.1.2.d	House of Access	Yes
13.1.2.e	Circulation	Yes
13.1.2.f.i	Landscape	Yes
13.1.2.f.ii-vi	Landscape	Yes
13.1.2.g	Hardscape	Yes
13.1.2.h	Amenities	Yes
13.1.2.i	Seating	Yes
13.1.2.j	Tables	Yes
13.1.2.k	Bicycle Parking	Yes
13.1.2.l	Signage	Yes
13.1.2.m	Litter Receptacles	Yes
13.1.2.n	Lighting	Yes
13.1.2.0	Irrigation & Drainage	Yes
13.1.2.p	Accessory Structures	Yes
13.1.3.b.i	Develpoment Standards	Yes
13.1.3.e.i	Develpoment Standards	Yes
13.1.3.e.11	Design Standards	Yes
13.1.3.a	Required	Proposed
Lot Size	8000 SF (min), 2 Acres (max)	22,375 SF
Landscape Area	50% (min), 100% (max)	51.5%
Permeable Area	85% min	86.4%
Seating	NA	
Tables	NA	
Large Trees	1 per 1,225SF (min - 19)	24

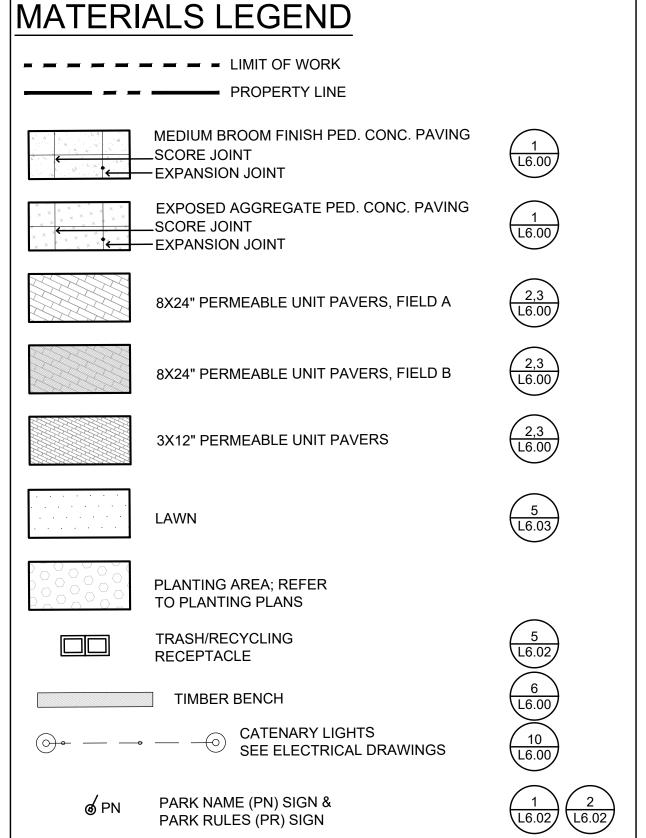



PROJECT NAME / CLIENT

PREPARED BY:

YARDS - CIVIC SPACE

CWDG PROJECT NUMBER: 2036						
ISSUANCES:						
	REV	# DATE D	ESCRIPTION			
	01	04.26.23	ADDENDU			
	02	05.22.23	ADDENDU			

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02 05.22.23 ADDENDUM #2
03 06.02.23 FIELD BULLETIN #1
04 07.26.23 FIELD BULLETIN #2


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MATERIALS
PLAN

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CHECKED BY:	IR			
SCALE:				
DATE:	04/2	26/2023	}	
SHEET	4	OF	11	


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LANDSCAPE LAYOUT NOTES

- 1. THE SITE PLAN IS BASED ON EXISTING CONDITIONS INFORMATION PROVIDED BY OTHERS. COPLEY WOLFF DESIGN GROUP IS NOT RESPONSIBLE FOR THE ACCURACY OR COMPLETENESS
- THE CONTRACTOR SHALL VERIFY ALL CONDITIONS IN THE FIELD AND REPORT ANY AND ALL DISCREPANCIES TO THE OWNER'S REPRESENTATIVE. ANY ALTERATIONS TO THESE DRAWINGS MADE IN THE FIELD SHALL BE PROMPTLY REPORTED BY THE CONTRACTOR TO THE OWNER'S REPRESENTATIVE AND RECORDED ON RECORD DRAWINGS.
- CONSULT ALL DRAWINGS AND SPECIFICATIONS FOR COORDINATION REQUIREMENTS BETWEEN
- 3. THE CONTRACTOR SHALL NOTIFY OWNER'S REPRESENTATIVE IMMEDIATELY OF ANY AND ALL
- CONFLICTS BETWEEN PROPOSED SITE WORK AND WORK OF ALL OTHER TRADES.
- 4. THE CONTRACTOR SHALL BE RESPONSIBLE FOR DAMAGE INSIDE AND OUTSIDE THE LIMIT OF WORK LINE DUE TO CONTRACT OPERATIONS. CONTRACTOR SHALL RESTORE DAMAGED AREAS BEYOND CONTRACT LIMITS TO THEIR ORIGINAL CONDITION AT NO ADDITIONAL COST TO THE
- 5. THE CONTRACTOR SHALL CONTACT THE PROPER AUTHORITIES IN WRITING TO CONFIRM THE LOCATIONS OF ALL EXISTING UTILITIES BEFORE COMMENCING WORK. ANY DAMAGE DUE TO THE FAILURE OF THE CONTRACTOR TO CONTACT AUTHORITIES SHALL BE BORNE BY THE CONTRACTOR. THE CONTRACTOR SHALL REPAIR ANY DAMAGE INCURRED DURING
- CONSTRUCTION TO EXISTING UTILITIES SCHEDULED TO REMAIN AT NO COST TO THE OWNER. 6. EXISTING STRUCTURES, IMPROVEMENTS, APPURTENANCES AND VEGETATION TO REMAIN SHALL BE PROTECTED FROM DAMAGE. ANY DAMAGE TO EXISTING SITE IMPROVEMENTS TO REMAIN
- 7. THE CONTRACTOR SHALL COMPLY WITH ALL REQUIREMENTS OF PERMITS AND LICENSES ISSUED BY COGNIZANT FEDERAL, STATE, AND LOCAL AGENCIES.
- 8. THE CONTRACTOR SHALL COORDINATE ALL SITE UTILITY IMPROVEMENTS WITH PROPER
- 9. ALL LINES AND DIMENSIONS ARE PARALLEL OR PERPENDICULAR TO THE LINES FROM WHICH
- 10. THE CONTRACTOR SHALL BE RESPONSIBLE FOR ESTABLISHING ALL LINES, GRADES, AND OTHER SURVEY CONTROL TO COMPLETE THE WORK. THE CONTRACTOR SHALL BE RESPONSIBLE FOR THE MAINTENANCE AND PROTECTION OF THE SURVEY CONTROL REFERENCE POINTS AND LOCATION STAKES. THE CONTRACTOR SHALL EMPLOY A MASSACHUSETTS-LICENSED CONSTRUCTION, WHO SHALL ESTABLISH LINES AND LEVELS. THE CONTRACTOR SHALL BE
- 11. DIMENSIONS ARE APPROXIMATE BASED ON TAKE OFF FROM SURVEY. ACTUAL DIMENSIONS MAY VARY. NOTIFY THE OWNER'S REPRESENTATIVE IN THE EVENT OF DIMENSIONAL DISCREPANCIES.
- 12. THE CONTRACTOR TO STAKE OUT LAYOUT FOR APPROVAL PRIOR TO EXCAVATION.
- 13. THE CONTRACTOR SHALL PREPARE SAMPLE PANELS FOR EACH PAVING TYPE FOR APPROVAL OF WORKMANSHIP, FINISHES, COLORS, AND JOINTING PRIOR TO FINAL INSTALLATION.
- 14. SEE LANDSCAPE ARCHITECTURAL PLANS FOR LAYOUT OF MATERIALS AND SITE IMPROVEMENTS AND SEE CIVIL DRAWINGS FOR GRADING, DRAINAGE, UTILITIES, AND PARKING AND CURB

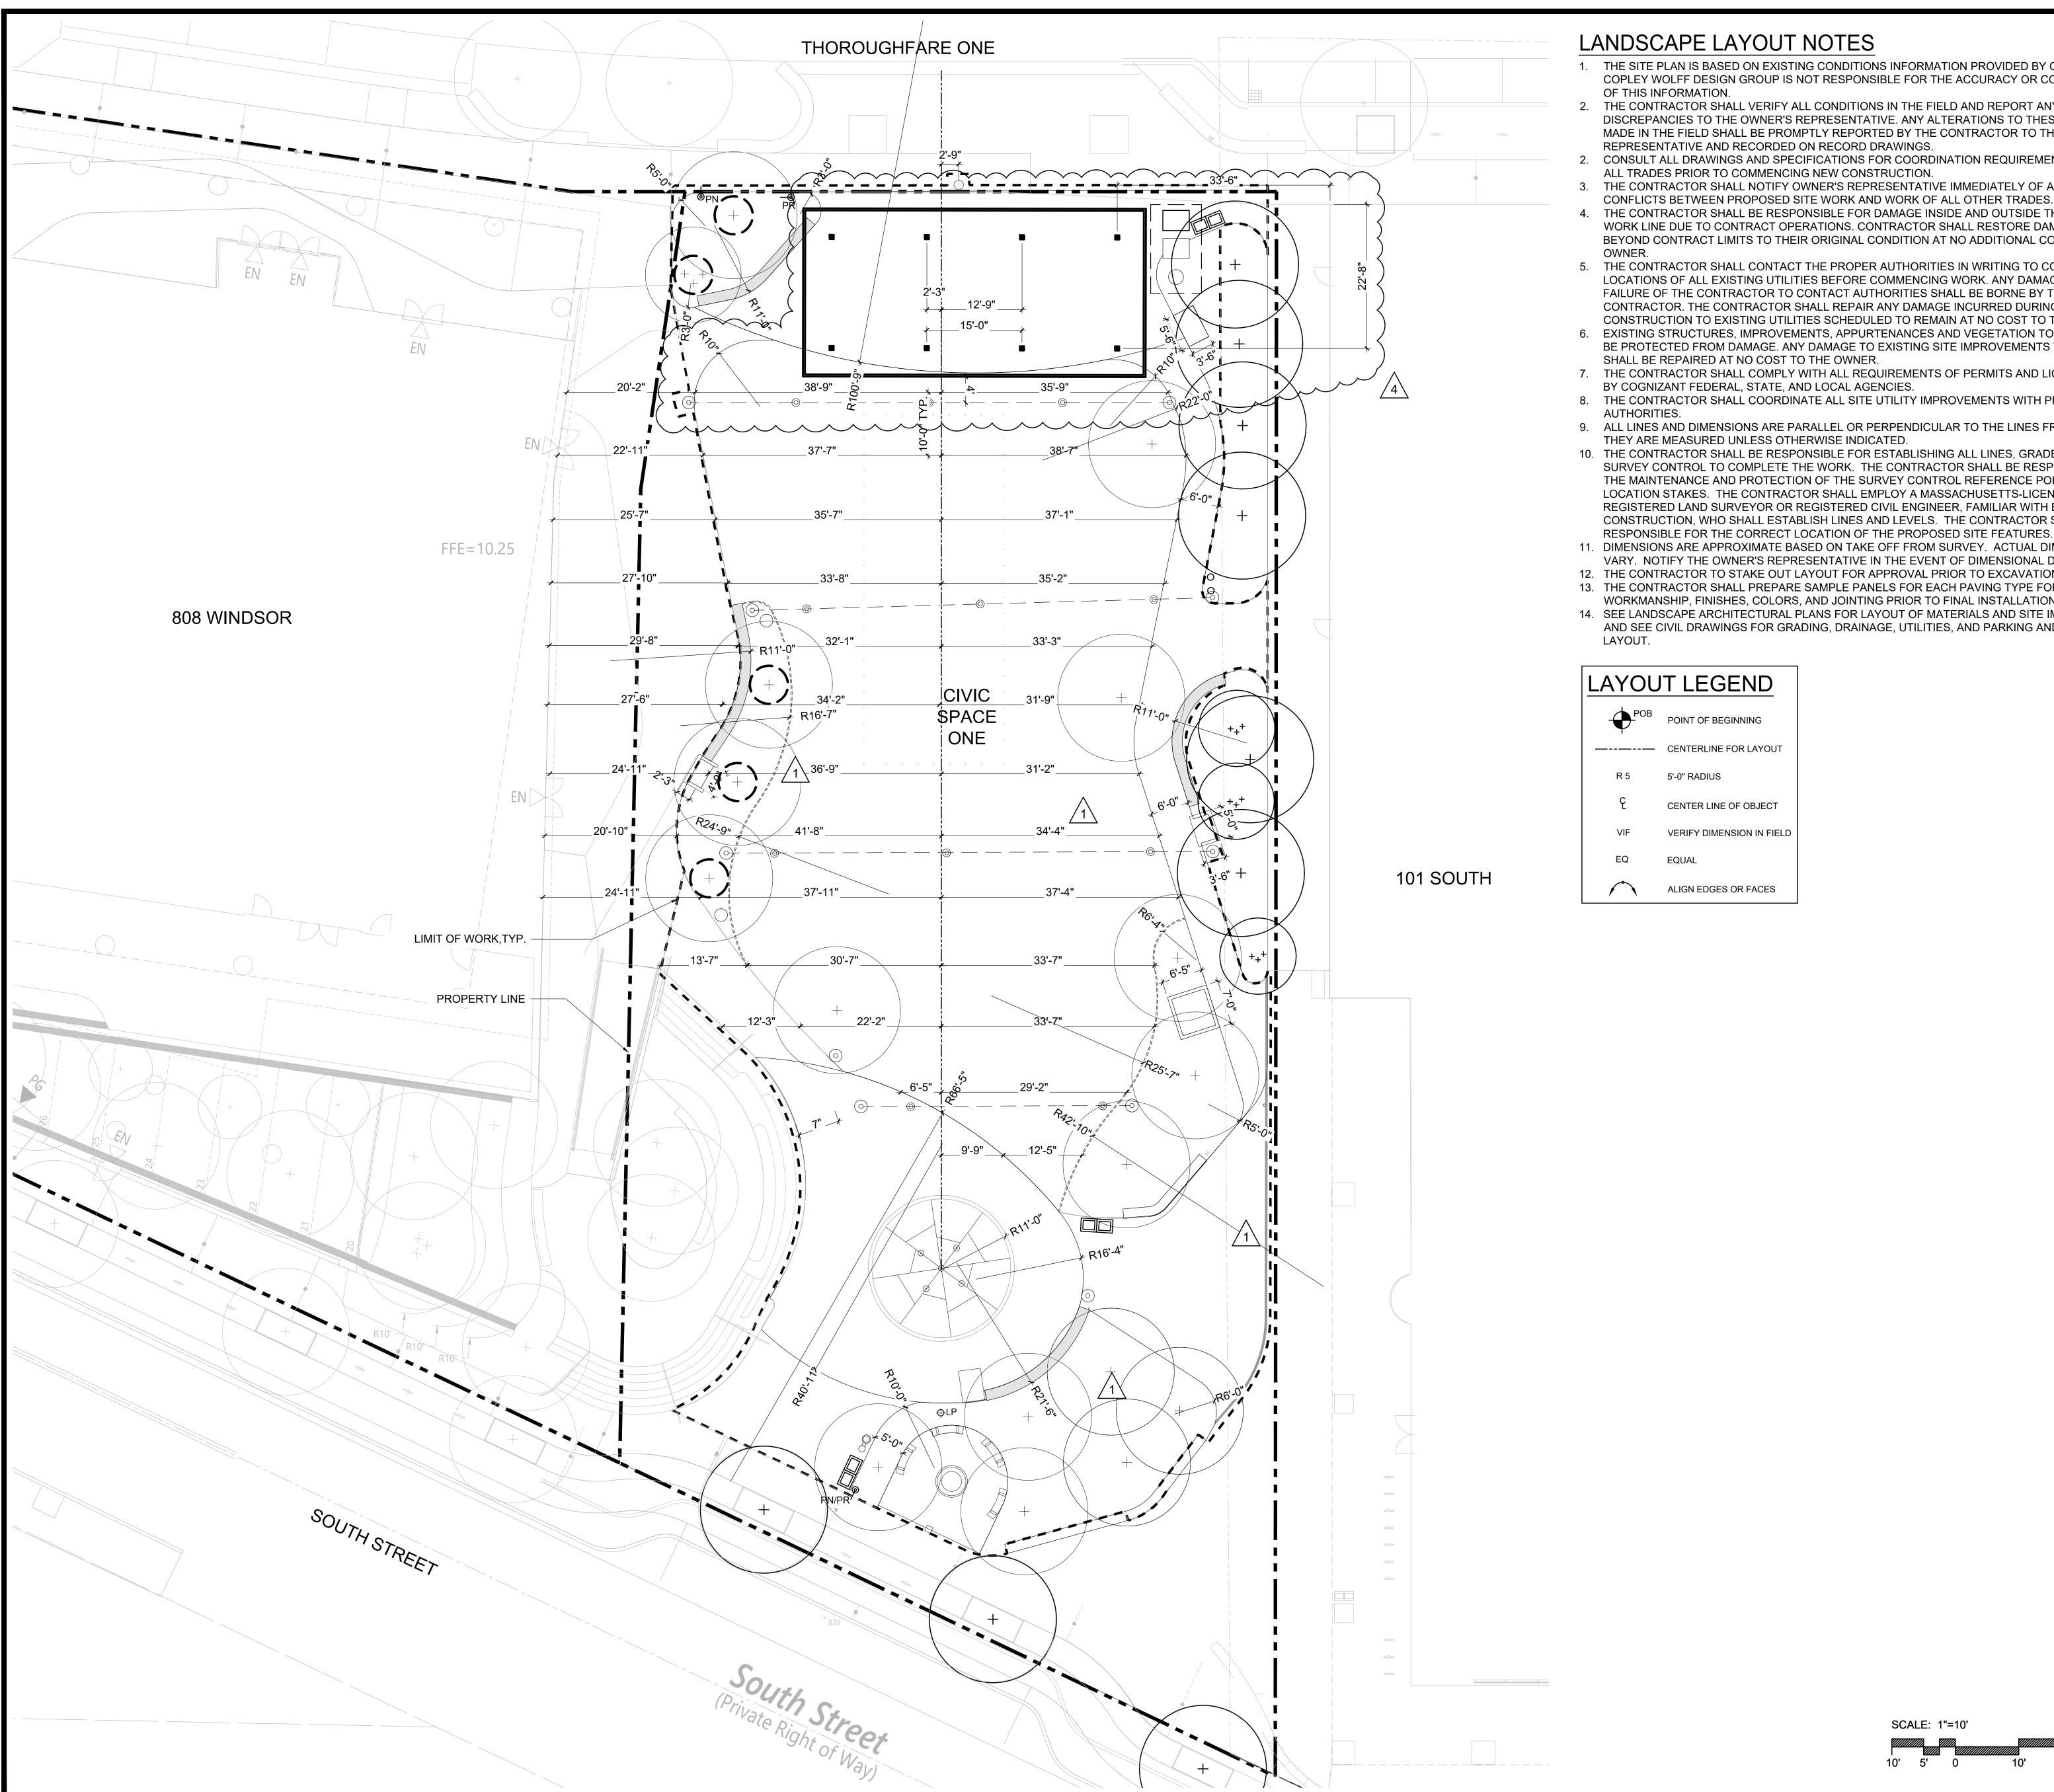

PROJECT NAME / CLIENT


PREPARED BY:

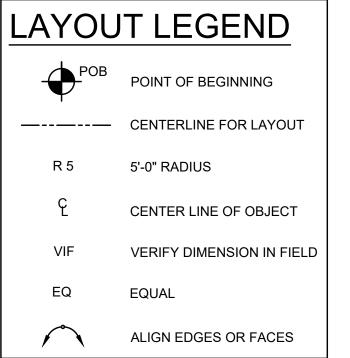CWDG PROJECT NUMBER: 2036 REV # DATE DESCRIPTION 01 04.26.23 ADDENDUM #1 02 05.22.23 ADDENDUM #2 03 | 06.02.23 | FIELD BULLETIN #1 04 | 07.26.23 | FIELD BULLETIN #2

100% CD SET

LAYOUT PLAN

04/26/2023

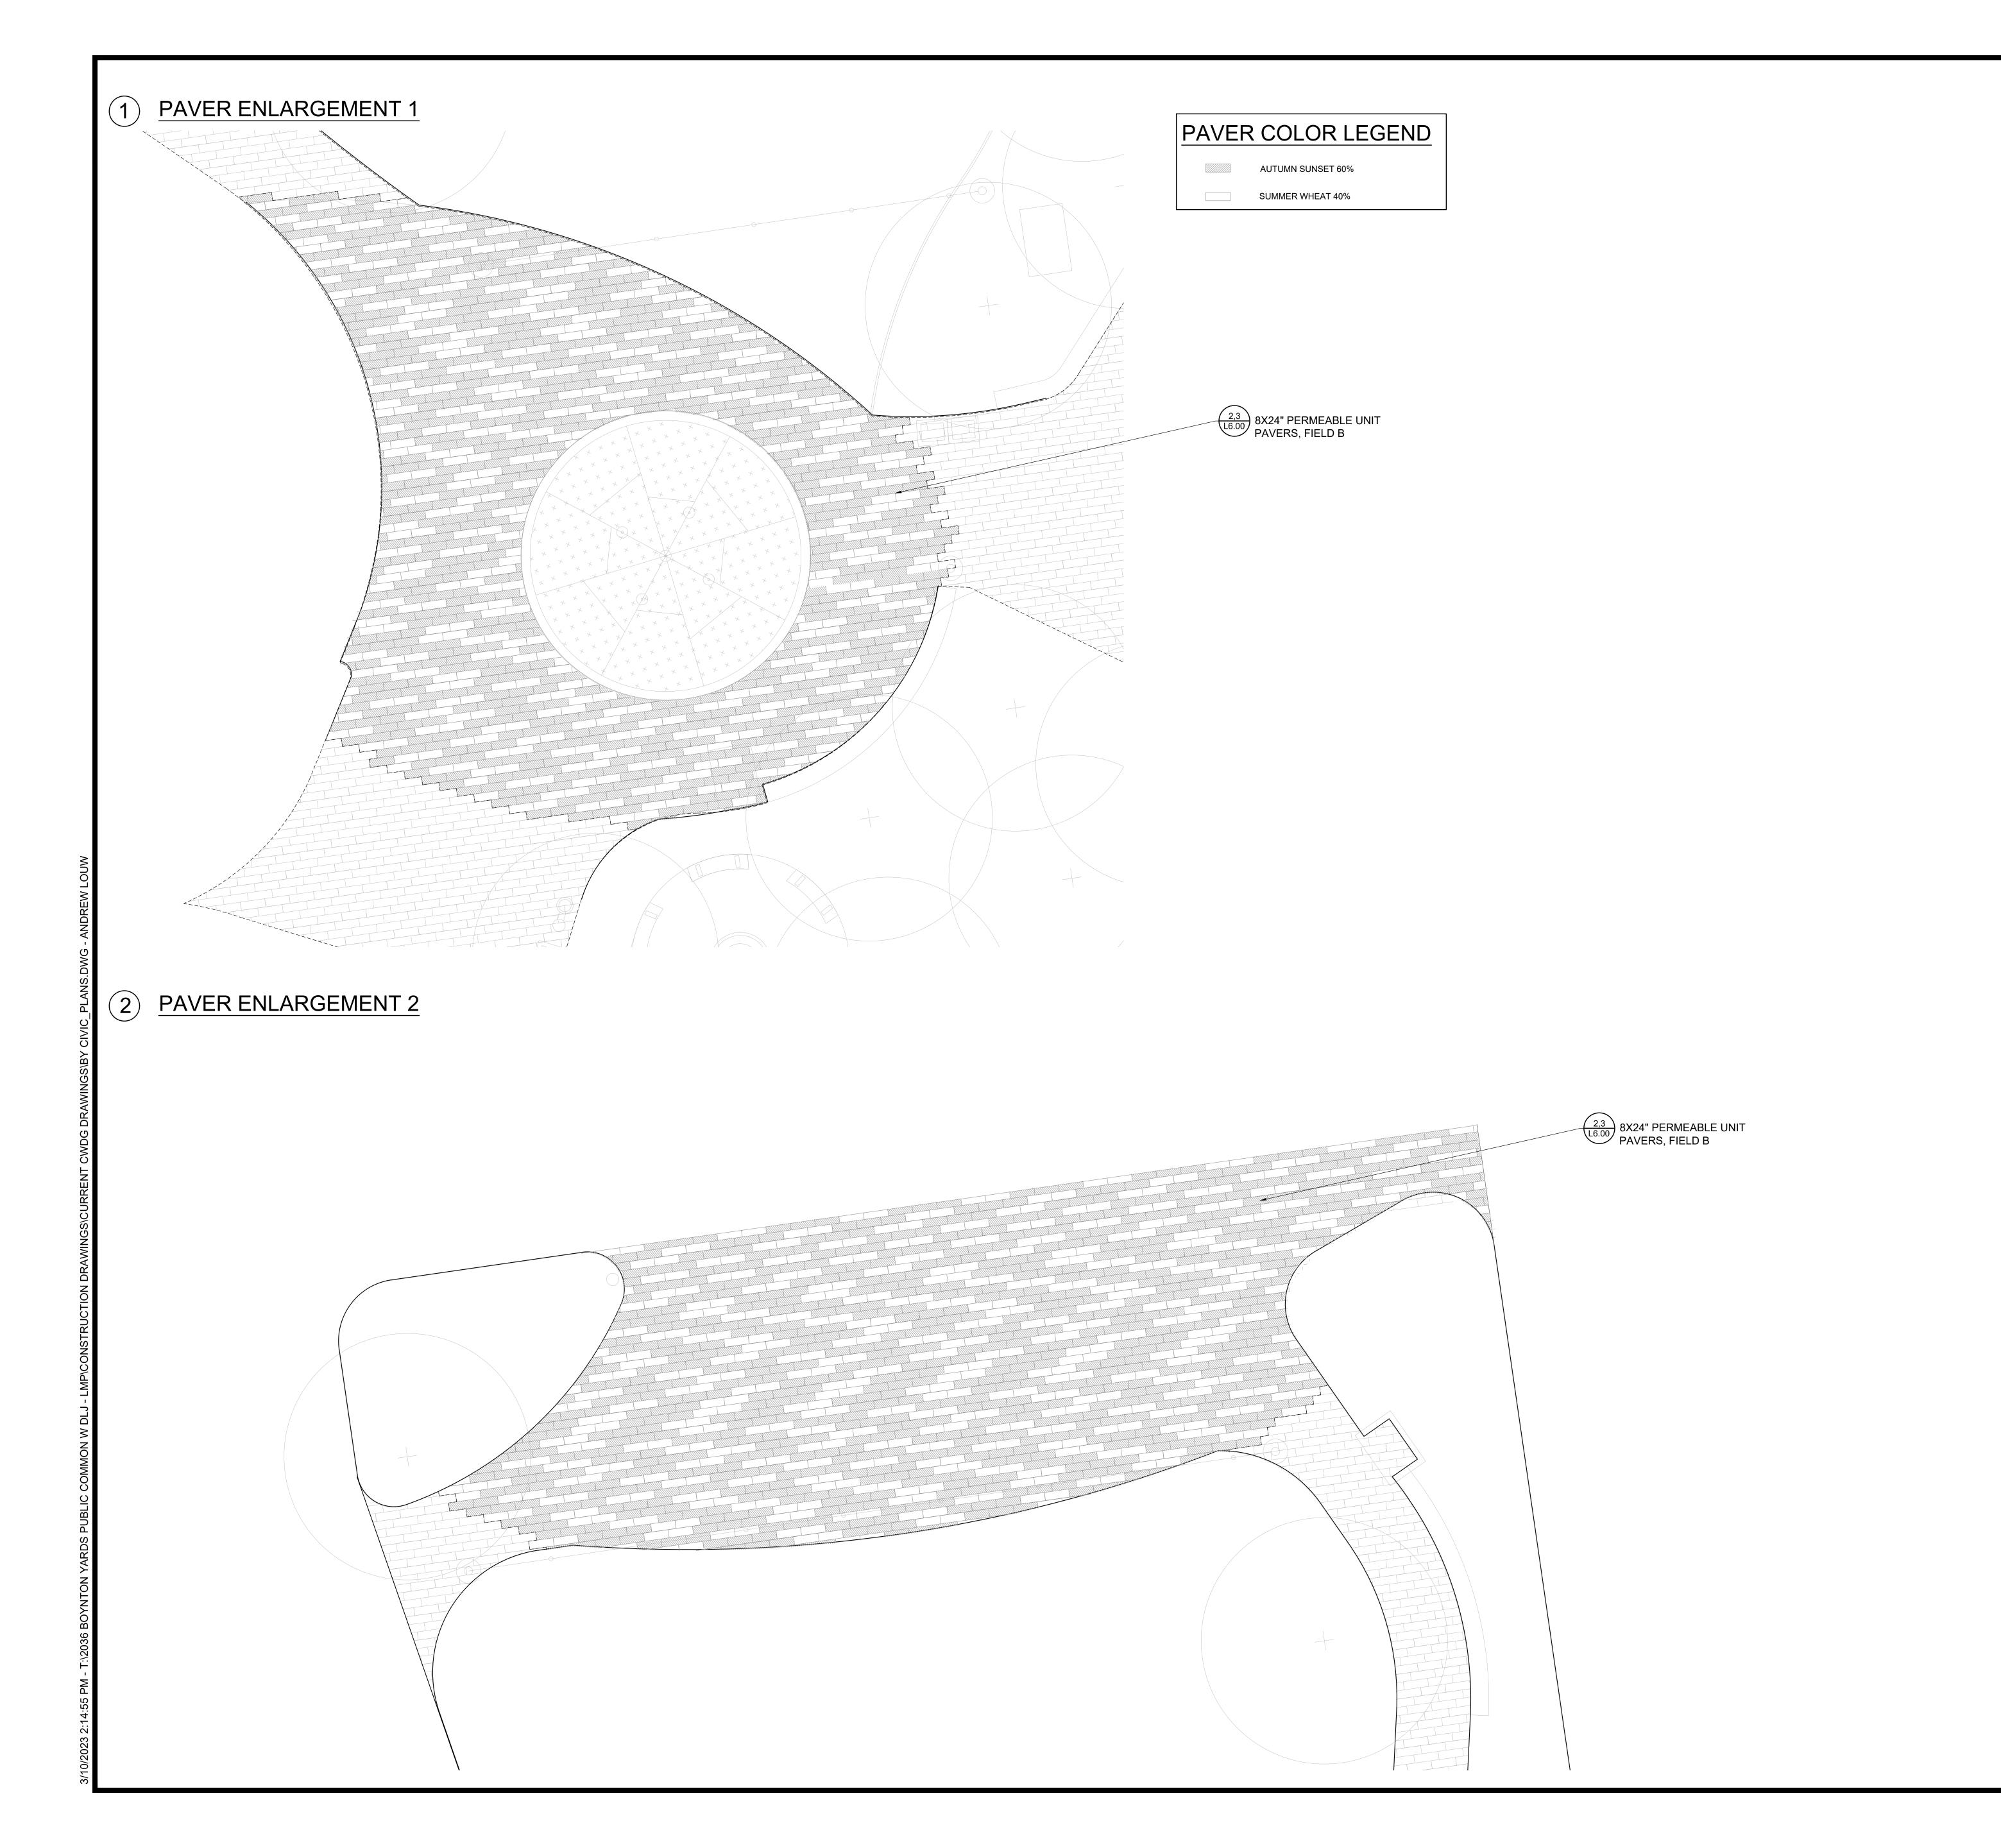

Copley Wolff

PROJECT NAME / CLIENT:

DS - CIVIC SPACE

CWDG PROJECT NUMBER: 2036

REV# DATE DESCRIPTION

STAMP:

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SPECIAL
PAVER AREA
ENLARGEMENT

DRAWN BY: AML

CHECKED BY: IR


SCALE: 5'

DATE: 03/10/2023

SHEET 5 OF 11

1"=5'

L3.01

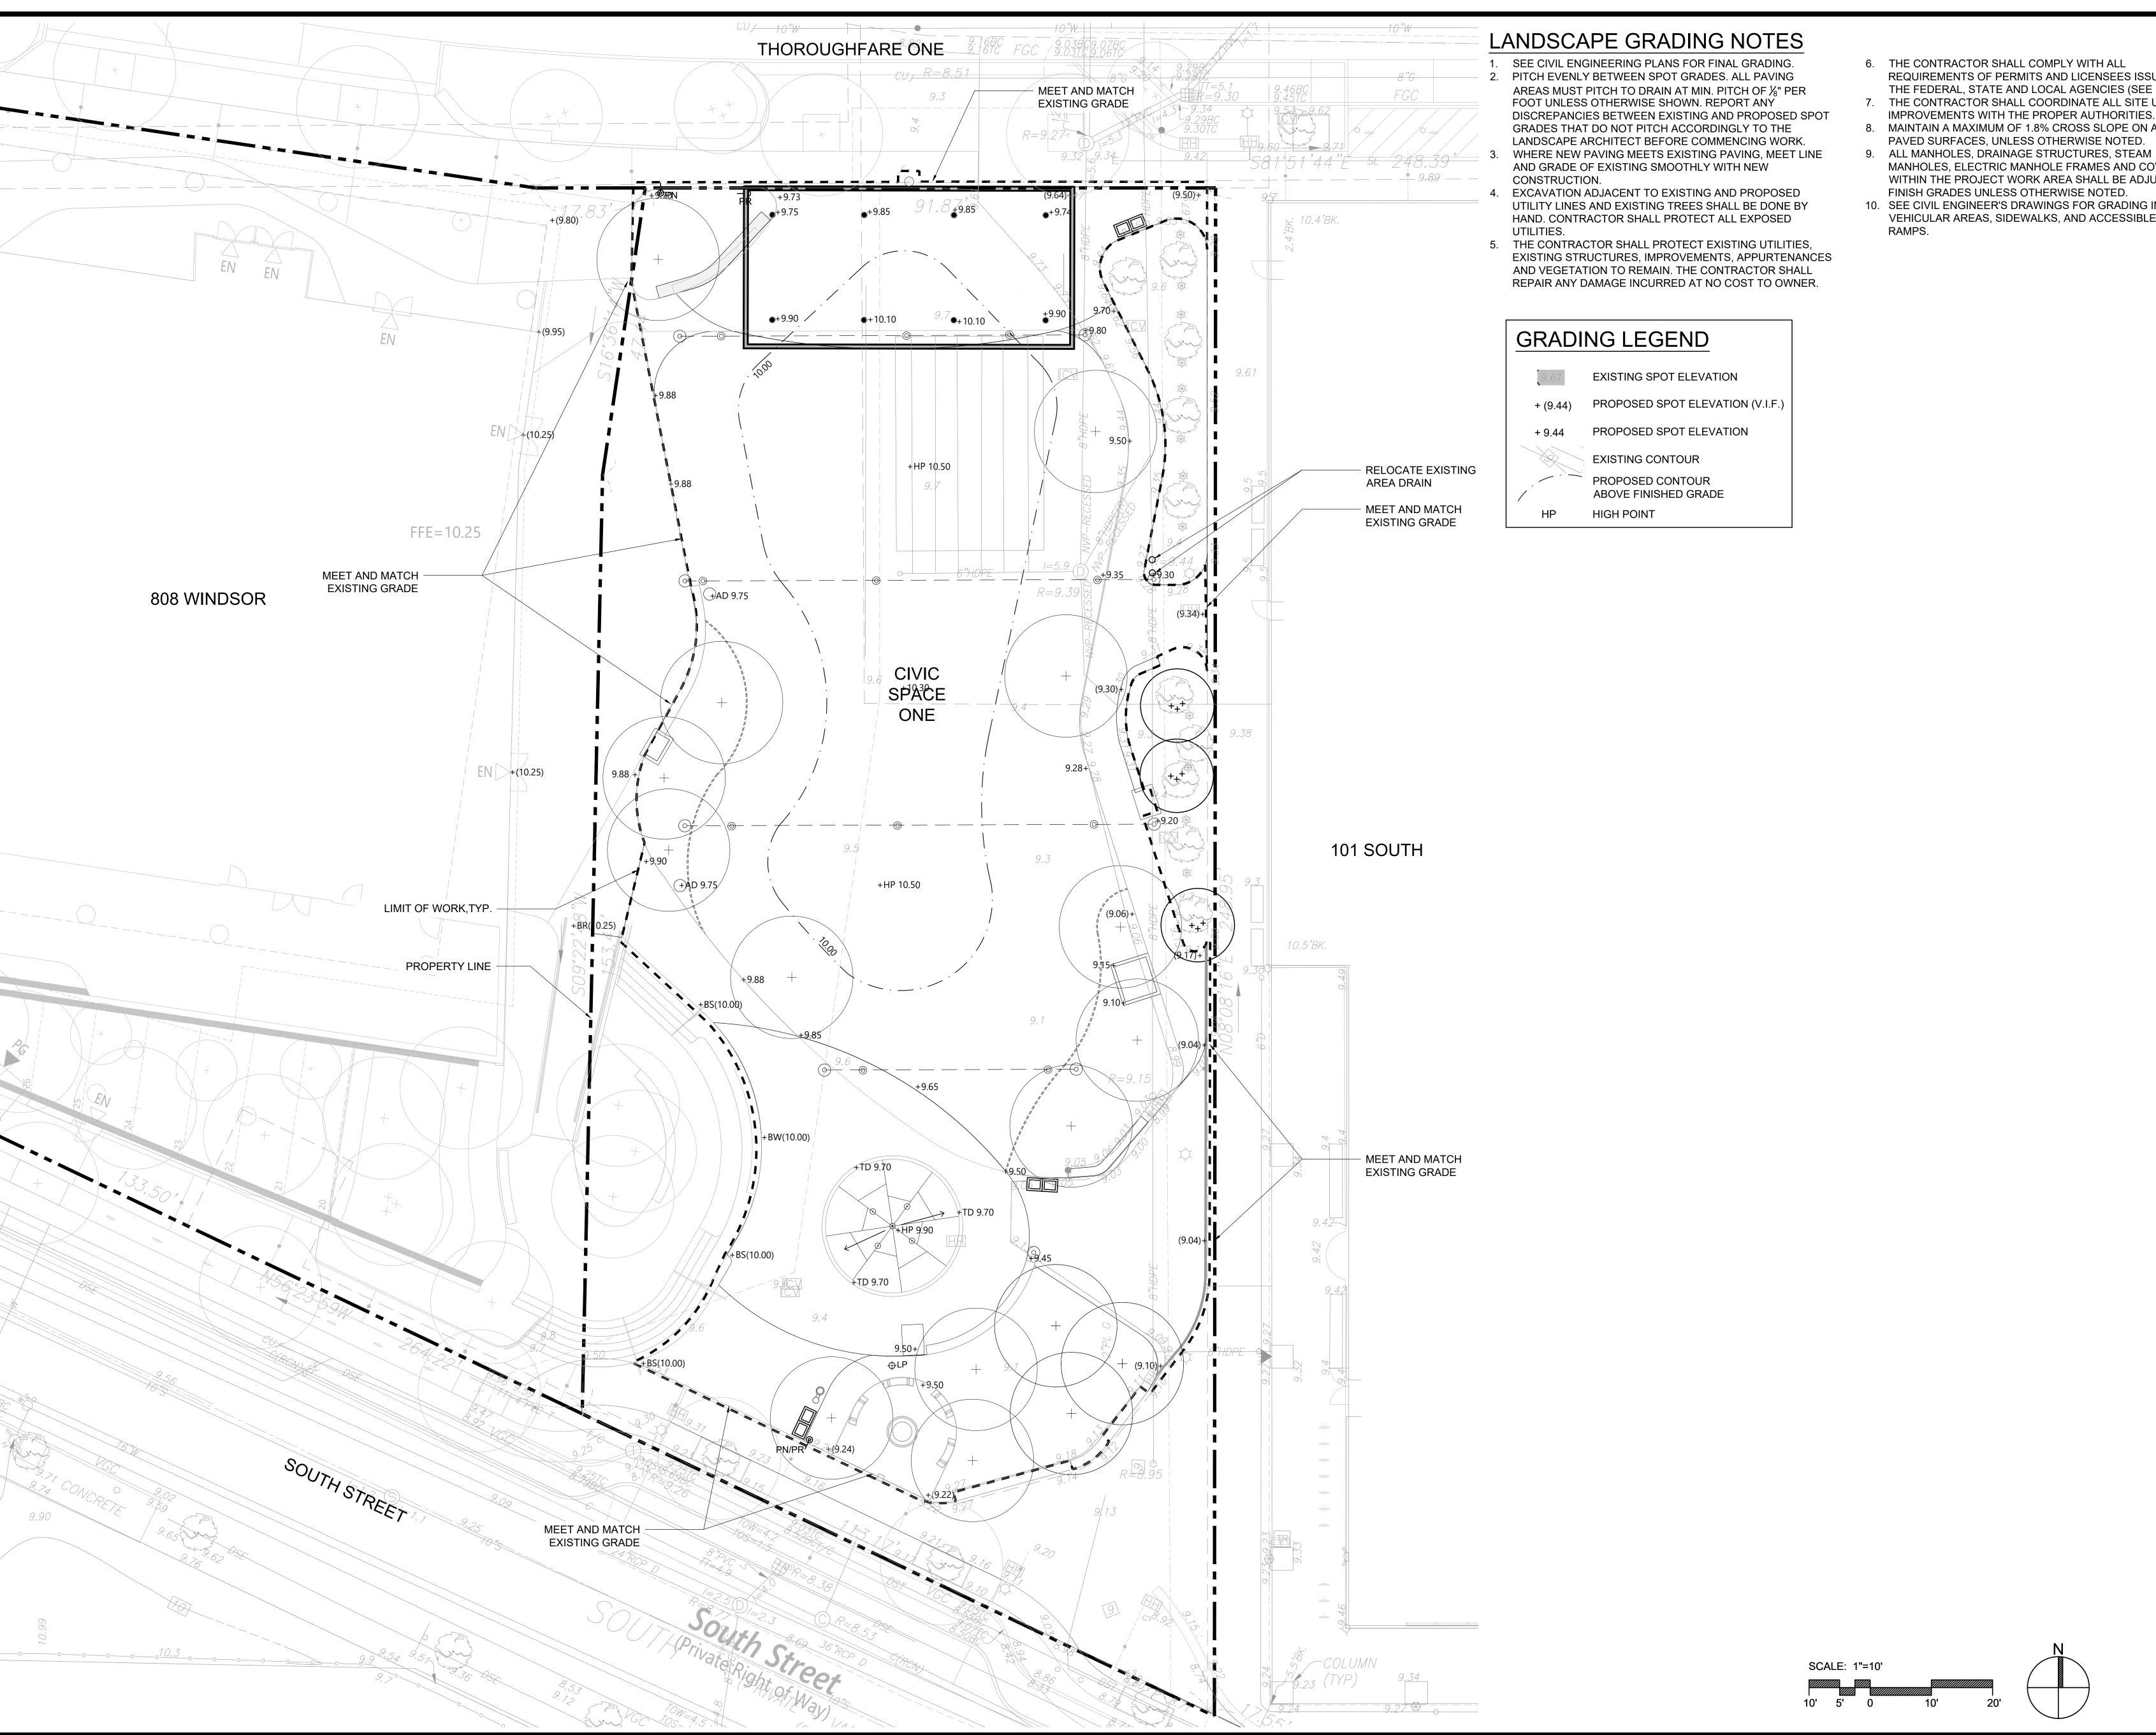

6. THE CONTRACTOR SHALL COMPLY WITH ALL REQUIREMENTS OF PERMITS AND LICENSEES ISSUED BY THE FEDERAL, STATE AND LOCAL AGENCIES (SEE SPECS). 7. THE CONTRACTOR SHALL COORDINATE ALL SITE UTILITY

IMPROVEMENTS WITH THE PROPER AUTHORITIES. 8. MAINTAIN A MAXIMUM OF 1.8% CROSS SLOPE ON ALL PAVED SURFACES, UNLESS OTHERWISE NOTED.

MANHOLES, ELECTRIC MANHOLE FRAMES AND COVERS WITHIN THE PROJECT WORK AREA SHALL BE ADJUSTED TO FINISH GRADES UNLESS OTHERWISE NOTED. 10. SEE CIVIL ENGINEER'S DRAWINGS FOR GRADING IN VEHICULAR AREAS, SIDEWALKS, AND ACCESSIBLE CURB

PROJECT NAME / CLIENT:


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REV # DATE DESCRIPTION

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GRADING PLAN

03/10/2023



PLANTING AND SOIL NOTES

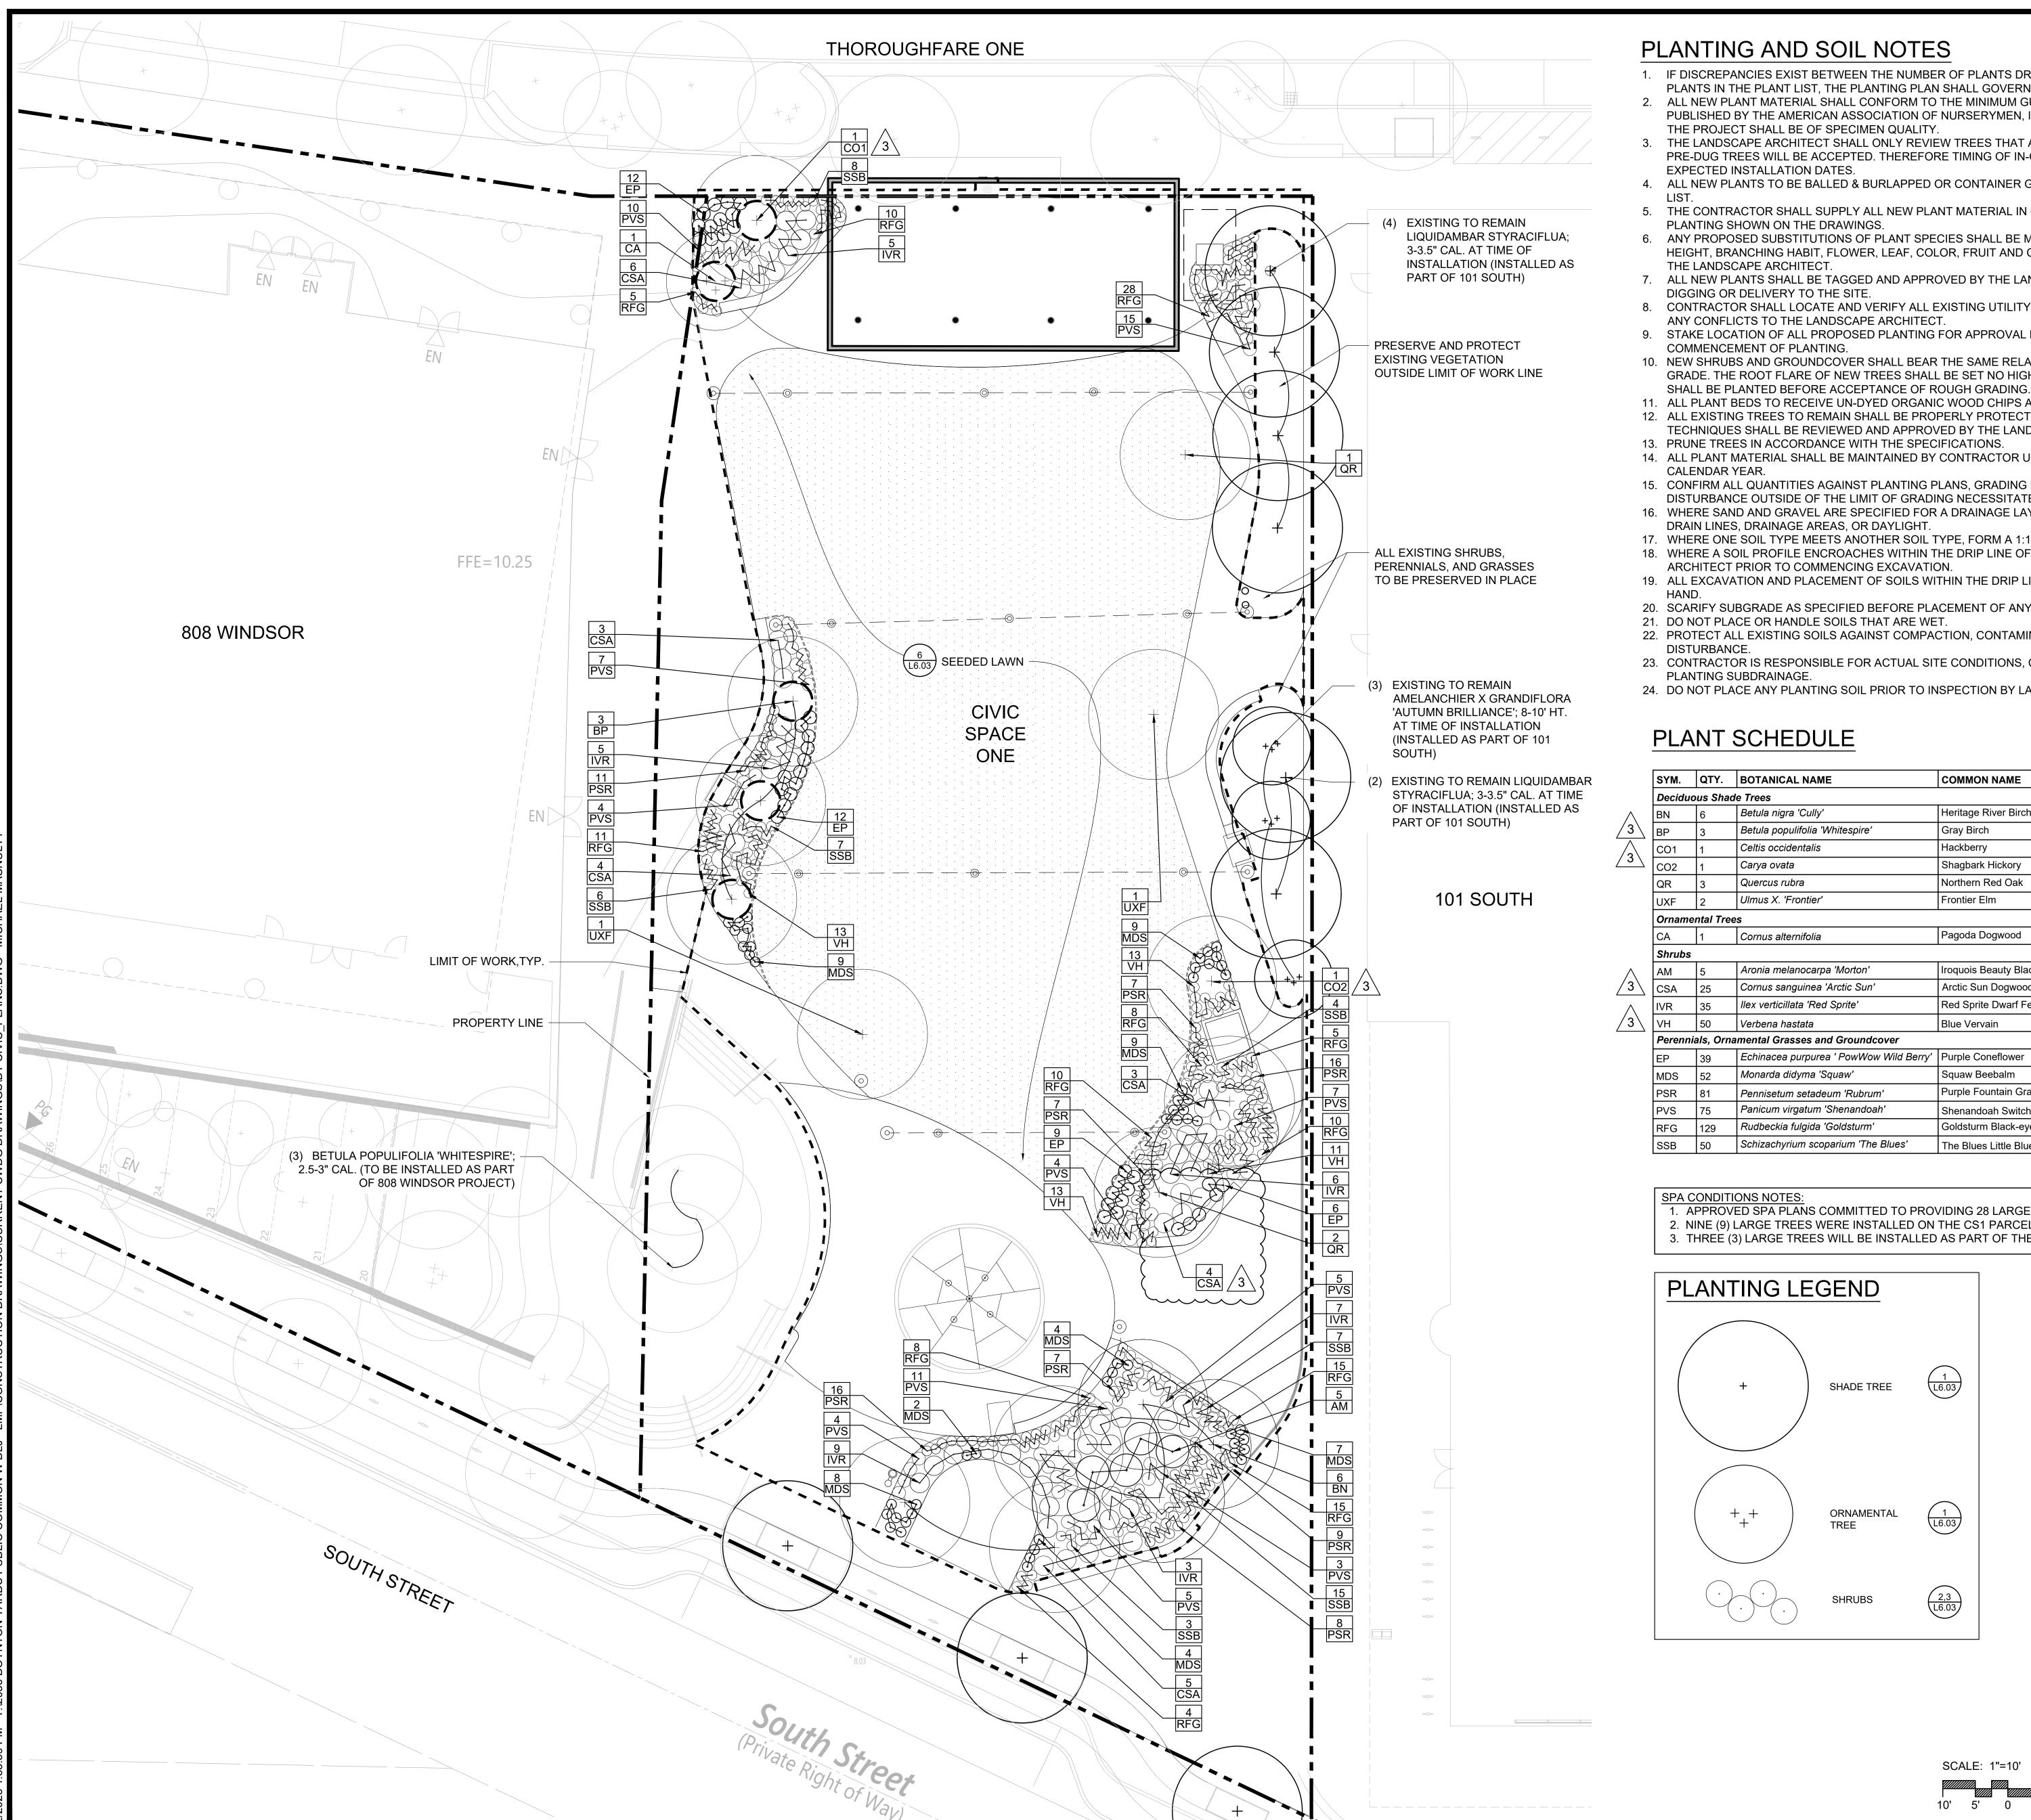
- 1. IF DISCREPANCIES EXIST BETWEEN THE NUMBER OF PLANTS DRAWN ON THE PLANTING PLAN AND THE NUMBER OF PLANTS IN THE PLANT LIST, THE PLANTING PLAN SHALL GOVERN.
- 2. ALL NEW PLANT MATERIAL SHALL CONFORM TO THE MINIMUM GUIDELINES ESTABLISHED FOR NURSERY STOCK PUBLISHED BY THE AMERICAN ASSOCIATION OF NURSERYMEN, INC. IN ADDITION, ALL NEW PLANT MATERIAL FOR THE PROJECT SHALL BE OF SPECIMEN QUALITY.
- 3. THE LANDSCAPE ARCHITECT SHALL ONLY REVIEW TREES THAT ARE IN THE GROUND AT THE NURSERY. NO PRE-DUG TREES WILL BE ACCEPTED. THEREFORE TIMING OF IN-GROUND REVIEWS MUST BE COORDINATED WITH EXPECTED INSTALLATION DATES.
- 4. ALL NEW PLANTS TO BE BALLED & BURLAPPED OR CONTAINER GROWN, UNLESS OTHERWISE NOTED ON THE PLANT
- 5. THE CONTRACTOR SHALL SUPPLY ALL NEW PLANT MATERIAL IN QUANTITIES SUFFICIENT TO COMPLETE THE
- 6. ANY PROPOSED SUBSTITUTIONS OF PLANT SPECIES SHALL BE MADE WITH PLANTS OF EQUIVALENT OVERALL FORM, HEIGHT, BRANCHING HABIT, FLOWER, LEAF, COLOR, FRUIT AND CULTURE, AND ONLY AFTER WRITTEN APPROVAL OF
- 7. ALL NEW PLANTS SHALL BE TAGGED AND APPROVED BY THE LANDSCAPE ARCHITECT AT THE NURSERY PRIOR TO DIGGING OR DELIVERY TO THE SITE.
- 8. CONTRACTOR SHALL LOCATE AND VERIFY ALL EXISTING UTILITY LINES PRIOR TO PLANTING AND SHALL REPORT ANY CONFLICTS TO THE LANDSCAPE ARCHITECT.
- 9. STAKE LOCATION OF ALL PROPOSED PLANTING FOR APPROVAL BY LANDSCAPE ARCHITECT PRIOR TO THE
- COMMENCEMENT OF PLANTING. 10. NEW SHRUBS AND GROUNDCOVER SHALL BEAR THE SAME RELATIONSHIP TO GRADE AS IT BORE TO PREVIOUS GRADE. THE ROOT FLARE OF NEW TREES SHALL BE SET NO HIGHER THAN 1" ABOVE FINISH GRADE. NO TREES
- 11. ALL PLANT BEDS TO RECEIVE UN-DYED ORGANIC WOOD CHIPS AS PER SPECIFICATIONS. 12. ALL EXISTING TREES TO REMAIN SHALL BE PROPERLY PROTECTED DURING CONSTRUCTION. PROTECTION
- TECHNIQUES SHALL BE REVIEWED AND APPROVED BY THE LANDSCAPE ARCHITECT. 13. PRUNE TREES IN ACCORDANCE WITH THE SPECIFICATIONS.
- 14. ALL PLANT MATERIAL SHALL BE MAINTAINED BY CONTRACTOR UNTIL FINAL ACCEPTANCE AND GUARANTEED FOR 1 CALENDAR YEAR.
- 15. CONFIRM ALL QUANTITIES AGAINST PLANTING PLANS, GRADING PLANS, AND SPECIFICATIONS, INCLUDING SITE
- DISTURBANCE OUTSIDE OF THE LIMIT OF GRADING NECESSITATED TO FACILITATE CONSTRUCTION. 16. WHERE SAND AND GRAVEL ARE SPECIFIED FOR A DRAINAGE LAYER, EXTEND DRAINAGE LAYER TO ASSOCIATED
- DRAIN LINES, DRAINAGE AREAS, OR DAYLIGHT.
- 17. WHERE ONE SOIL TYPE MEETS ANOTHER SOIL TYPE, FORM A 1:1 SLOPED BOUNDARY TRANSITION. 18. WHERE A SOIL PROFILE ENCROACHES WITHIN THE DRIP LINE OF EXISTING TREES, CONSULT WITH LANDSCAPE
- ARCHITECT PRIOR TO COMMENCING EXCAVATION. 19. ALL EXCAVATION AND PLACEMENT OF SOILS WITHIN THE DRIP LINE OF EXISTING TREES TO BE PERFORMED BY
- 20. SCARIFY SUBGRADE AS SPECIFIED BEFORE PLACEMENT OF ANY PLANTING SOILS.
- 21. DO NOT PLACE OR HANDLE SOILS THAT ARE WET.
- 22. PROTECT ALL EXISTING SOILS AGAINST COMPACTION, CONTAMINATION WITH CONSTRUCTION MATERIALS, AND ALL DISTURBANCE.
- 23. CONTRACTOR IS RESPONSIBLE FOR ACTUAL SITE CONDITIONS, COORDINATION OF SOILS PLACEMENT, AND PLANTING SUBDRAINAGE.
- 24. DO NOT PLACE ANY PLANTING SOIL PRIOR TO INSPECTION BY LANDSCAPE ARCHITECT.

PLANT SCHEDULE

	SYM.	QTY.	BOTANICAL NAME	COMMON NAME	SIZE	ROOT	COMMENTS
	Deciduous Shade Trees						
\wedge	BN	6	Betula nigra 'Cully'	Heritage River Birch	2.5" - 3" Cal.	B&B	Multi-stem
<u>/</u> 3\	BP	3	Betula populifolia 'Whitespire'	Gray Birch	2.5" - 3" Cal.	B&B	Single Stem
$\stackrel{\wedge}{\bigcirc}$	CO1	1	Celtis occidentalis	Hackberry	2.5" - 3" Cal.	B&B	Matched
<u>/</u> 3\	CO2	1	Carya ovata	Shagbark Hickory	3" - 3.5" Cal.	В&В	Matched
	QR	3	Quercus rubra	Northern Red Oak	2.5" - 3" Cal.	B&B	Matched
	UXF	2	Ulmus X. 'Frontier'	Frontier Elm	2.5" - 3" Cal.	B&B	Specimen
	Orname	ntal Tree	es				
	CA	1	Cornus alternifolia	Pagoda Dogwood	10-12' ht.	B&B	Matched
	Shrubs						
\wedge	AM	5	Aronia melanocarpa 'Morton'	Iroquois Beauty Black Chokeberry	#2	Cont.	24" O.C.
<u>/</u> 3\	CSA	25	Cornus sanguinea 'Arctic Sun'	Arctic Sun Dogwood	#3	Cont.	30" O.C.
\wedge	IVR	35	llex verticillata 'Red Sprite'	Red Sprite Dwarf Female Winterberry	#3	Cont.	36" O.C.
3	VH	50	Verbena hastata	Blue Vervain	#2	Cont.	18" O.C.
	Perenni	als, Orna	mental Grasses and Groundcover				
	EP	39	Echinacea purpurea ' PowWow Wild Berry'	Purple Coneflower	#2	Cont.	18" O.C.
	MDS	52	Monarda didyma 'Squaw'	Squaw Beebalm	#2	Cont.	18" O.C.
	PSR	81	Pennisetum setadeum 'Rubrum'	Purple Fountain Grass	#2	Cont.	18" O.C.
	PVS	75	Panicum virgatum 'Shenandoah'	Shenandoah Switch Grass	#2	Cont.	24" O.C.
	RFG	129	Rudbeckia fulgida 'Goldsturm'	Goldsturm Black-eyed Susan	#2	Cont.	18" O.C.

The Blues Little Bluestem

1. APPROVED SPA PLANS COMMITTED TO PROVIDING 28 LARGE TREES WITHIN THE CS1 PARCEL 2. NINE (9) LARGE TREES WERE INSTALLED ON THE CS1 PARCEL AS PART OF THE 101 SOUTH SCOPE. 3. THREE (3) LARGE TREES WILL BE INSTALLED AS PART OF THE APPROVED 808 WINDSOR SCOPE.

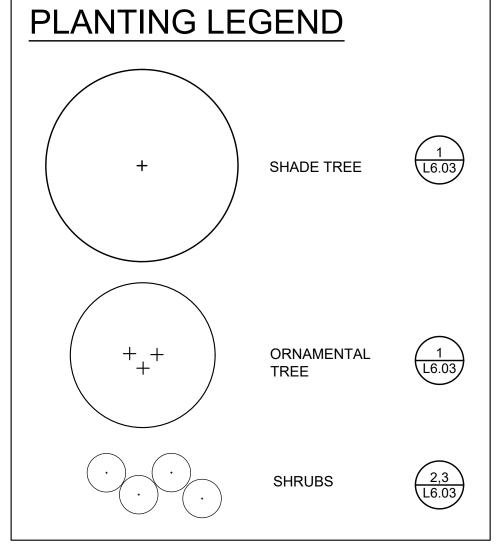

Schizachyrium scoparium 'The Blues'

PLANTING

100% CD SET

CWDG PROJECT NUMBER: 2036

REV # DATE DESCRIPTION

01 04.26.23 ADDENDUM #1

02 | 05.22.23 | ADDENDUM #2

03 | 06.02.23 | FIELD BULLETIN #1


PREPARED BY:

PROJECT NAME / CLIENT:

PLAN

04/26/2023


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PREPARED BY:

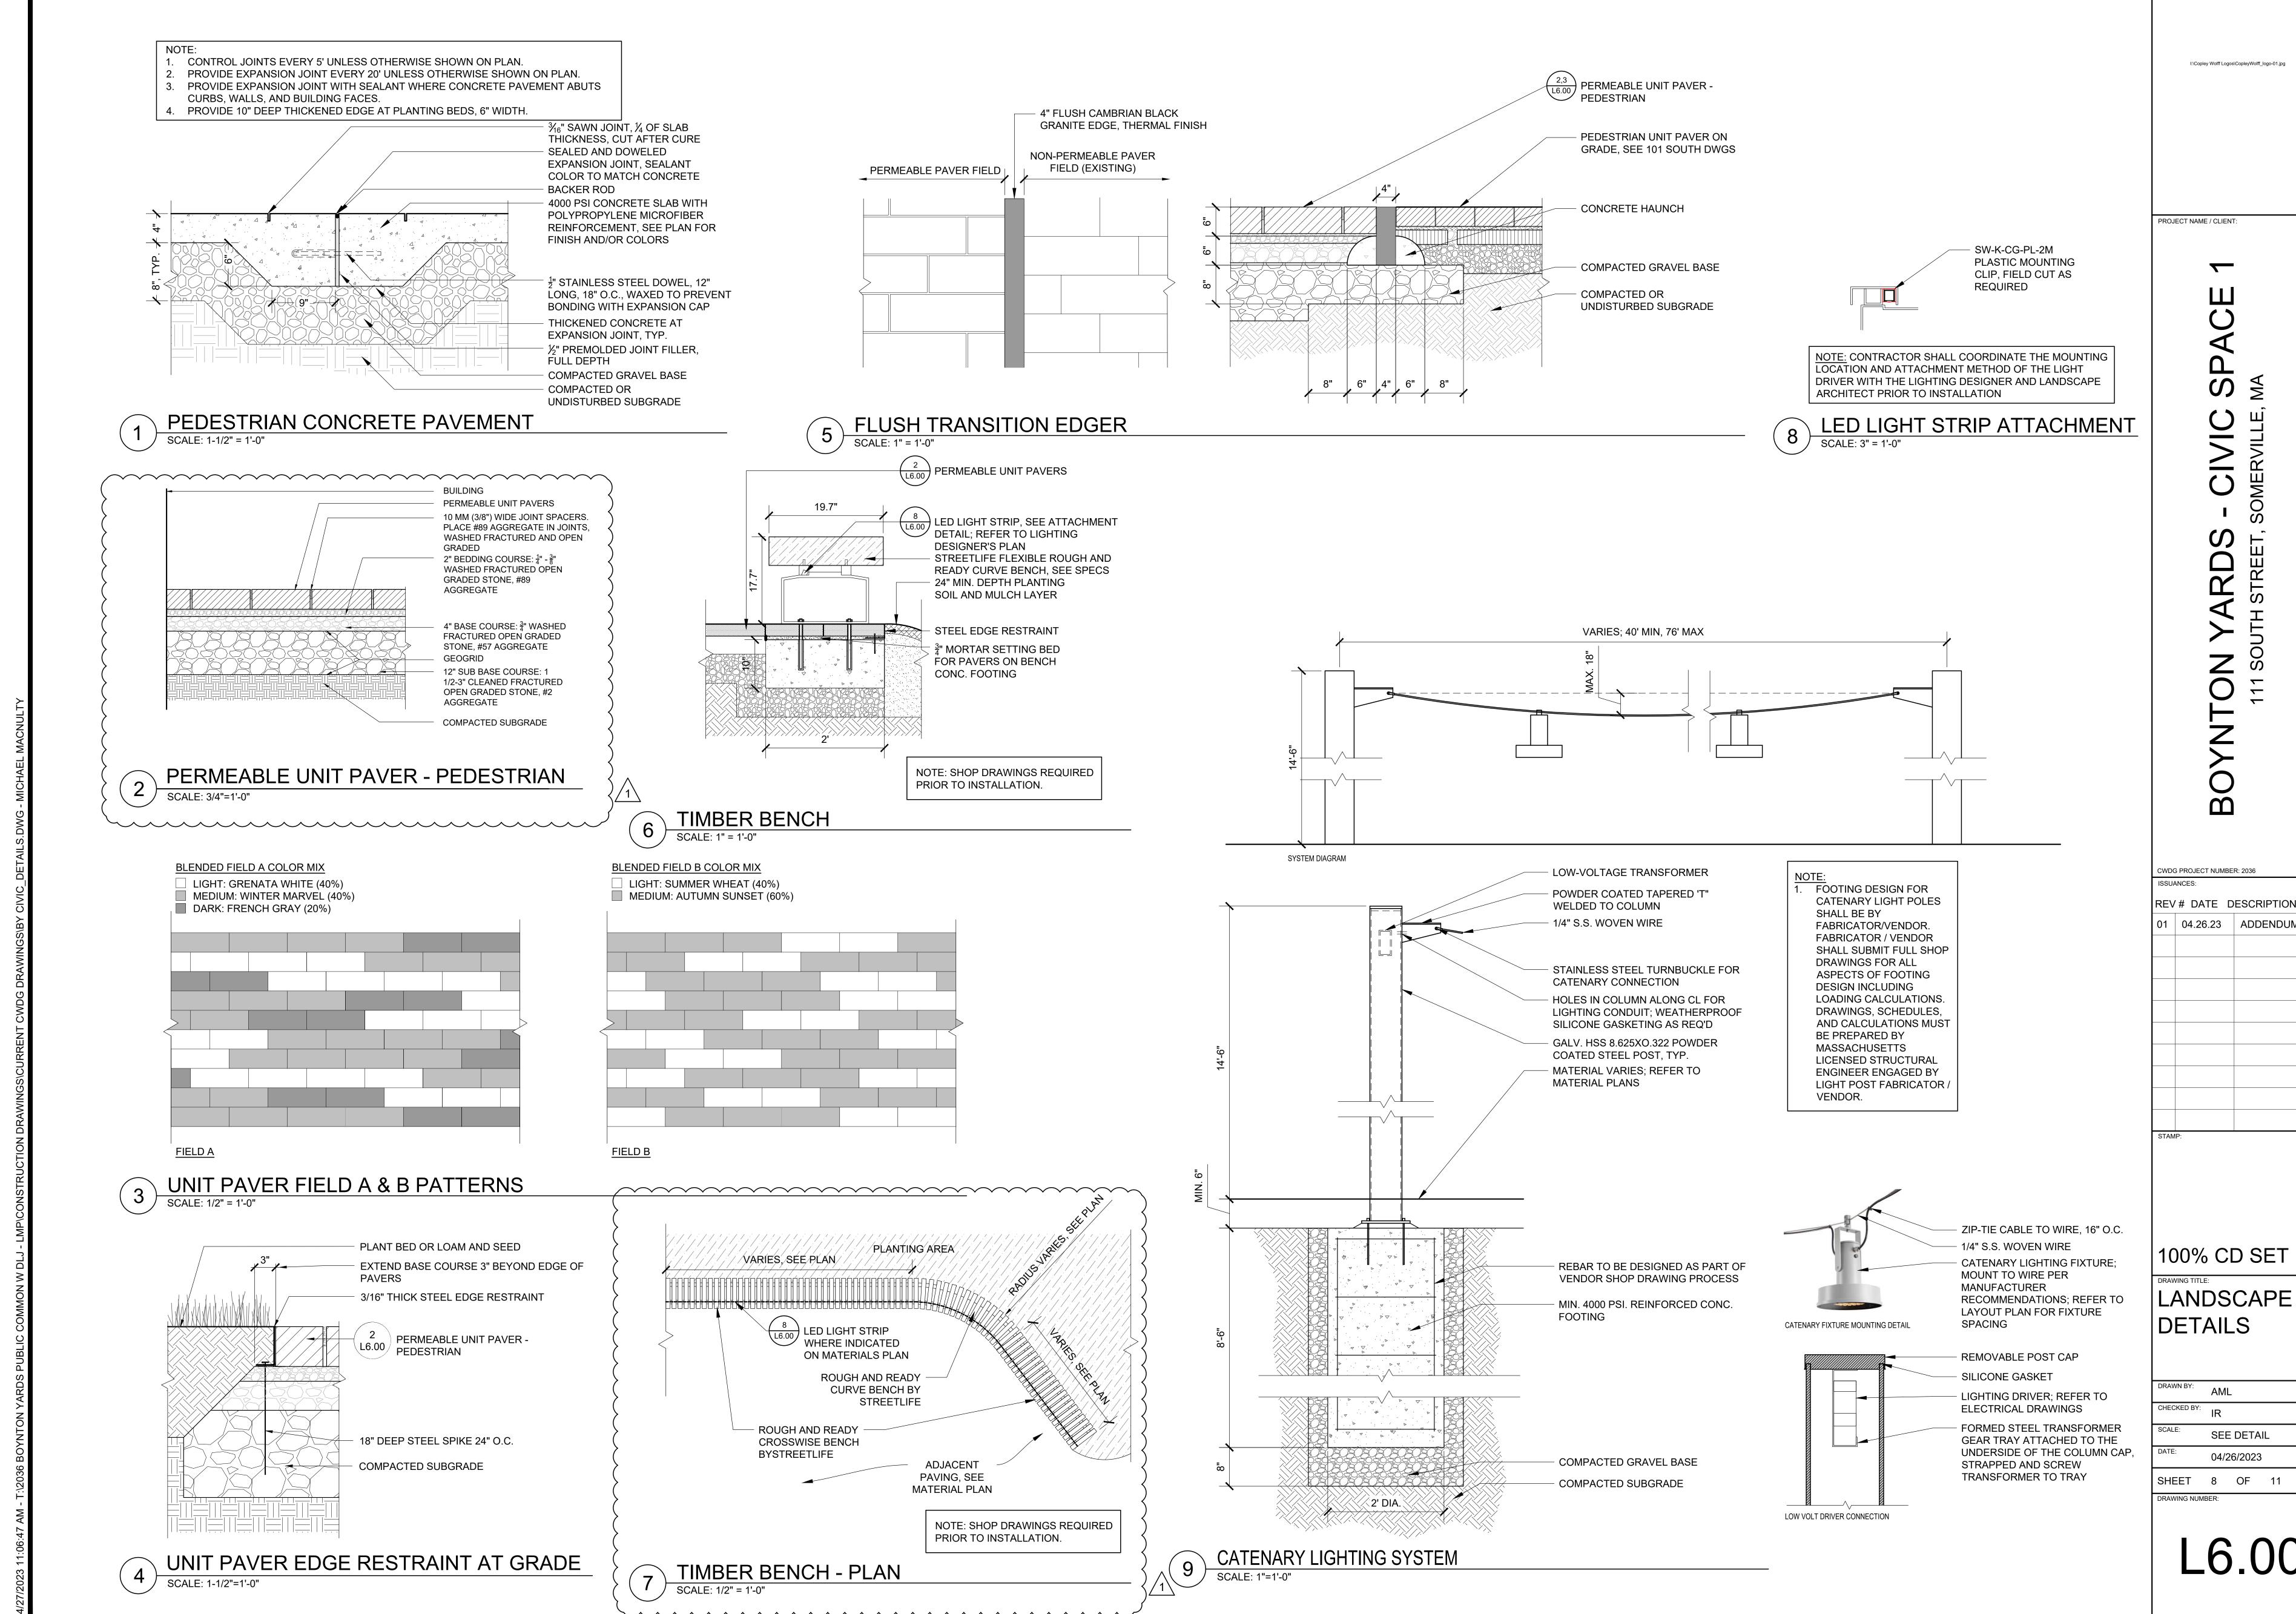REV # DATE DESCRIPTION 01 | 04.26.23 | ADDENDUM #1



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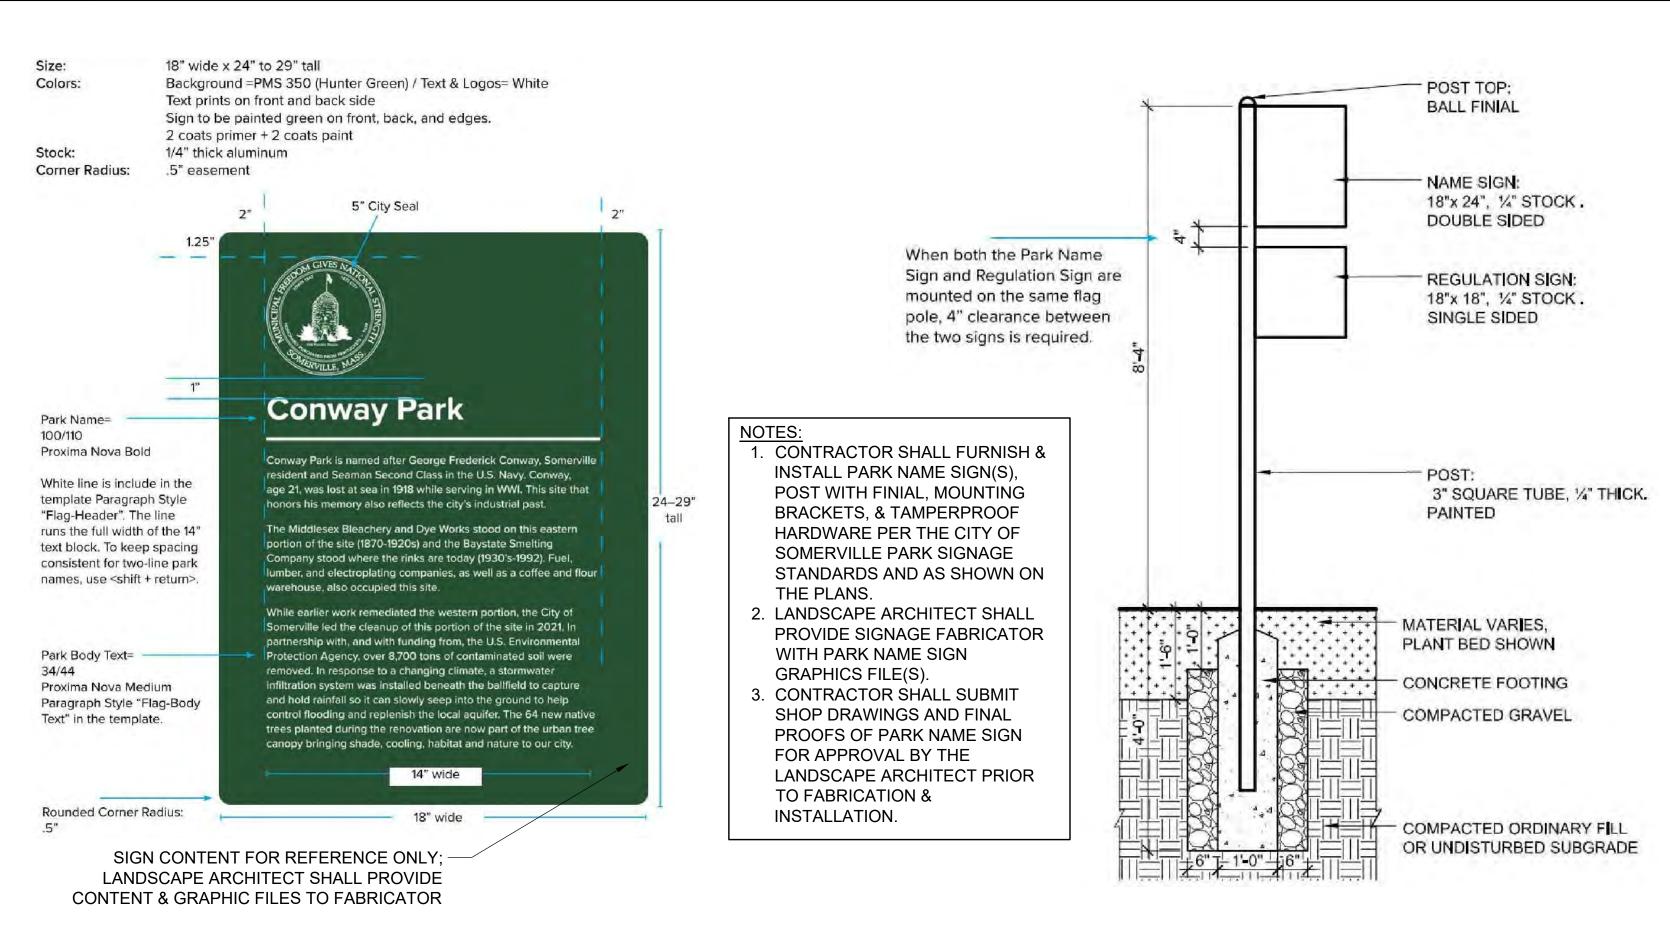
CWDG PROJECT NUMBER: 2036

REV # DATE DESCRIPTION

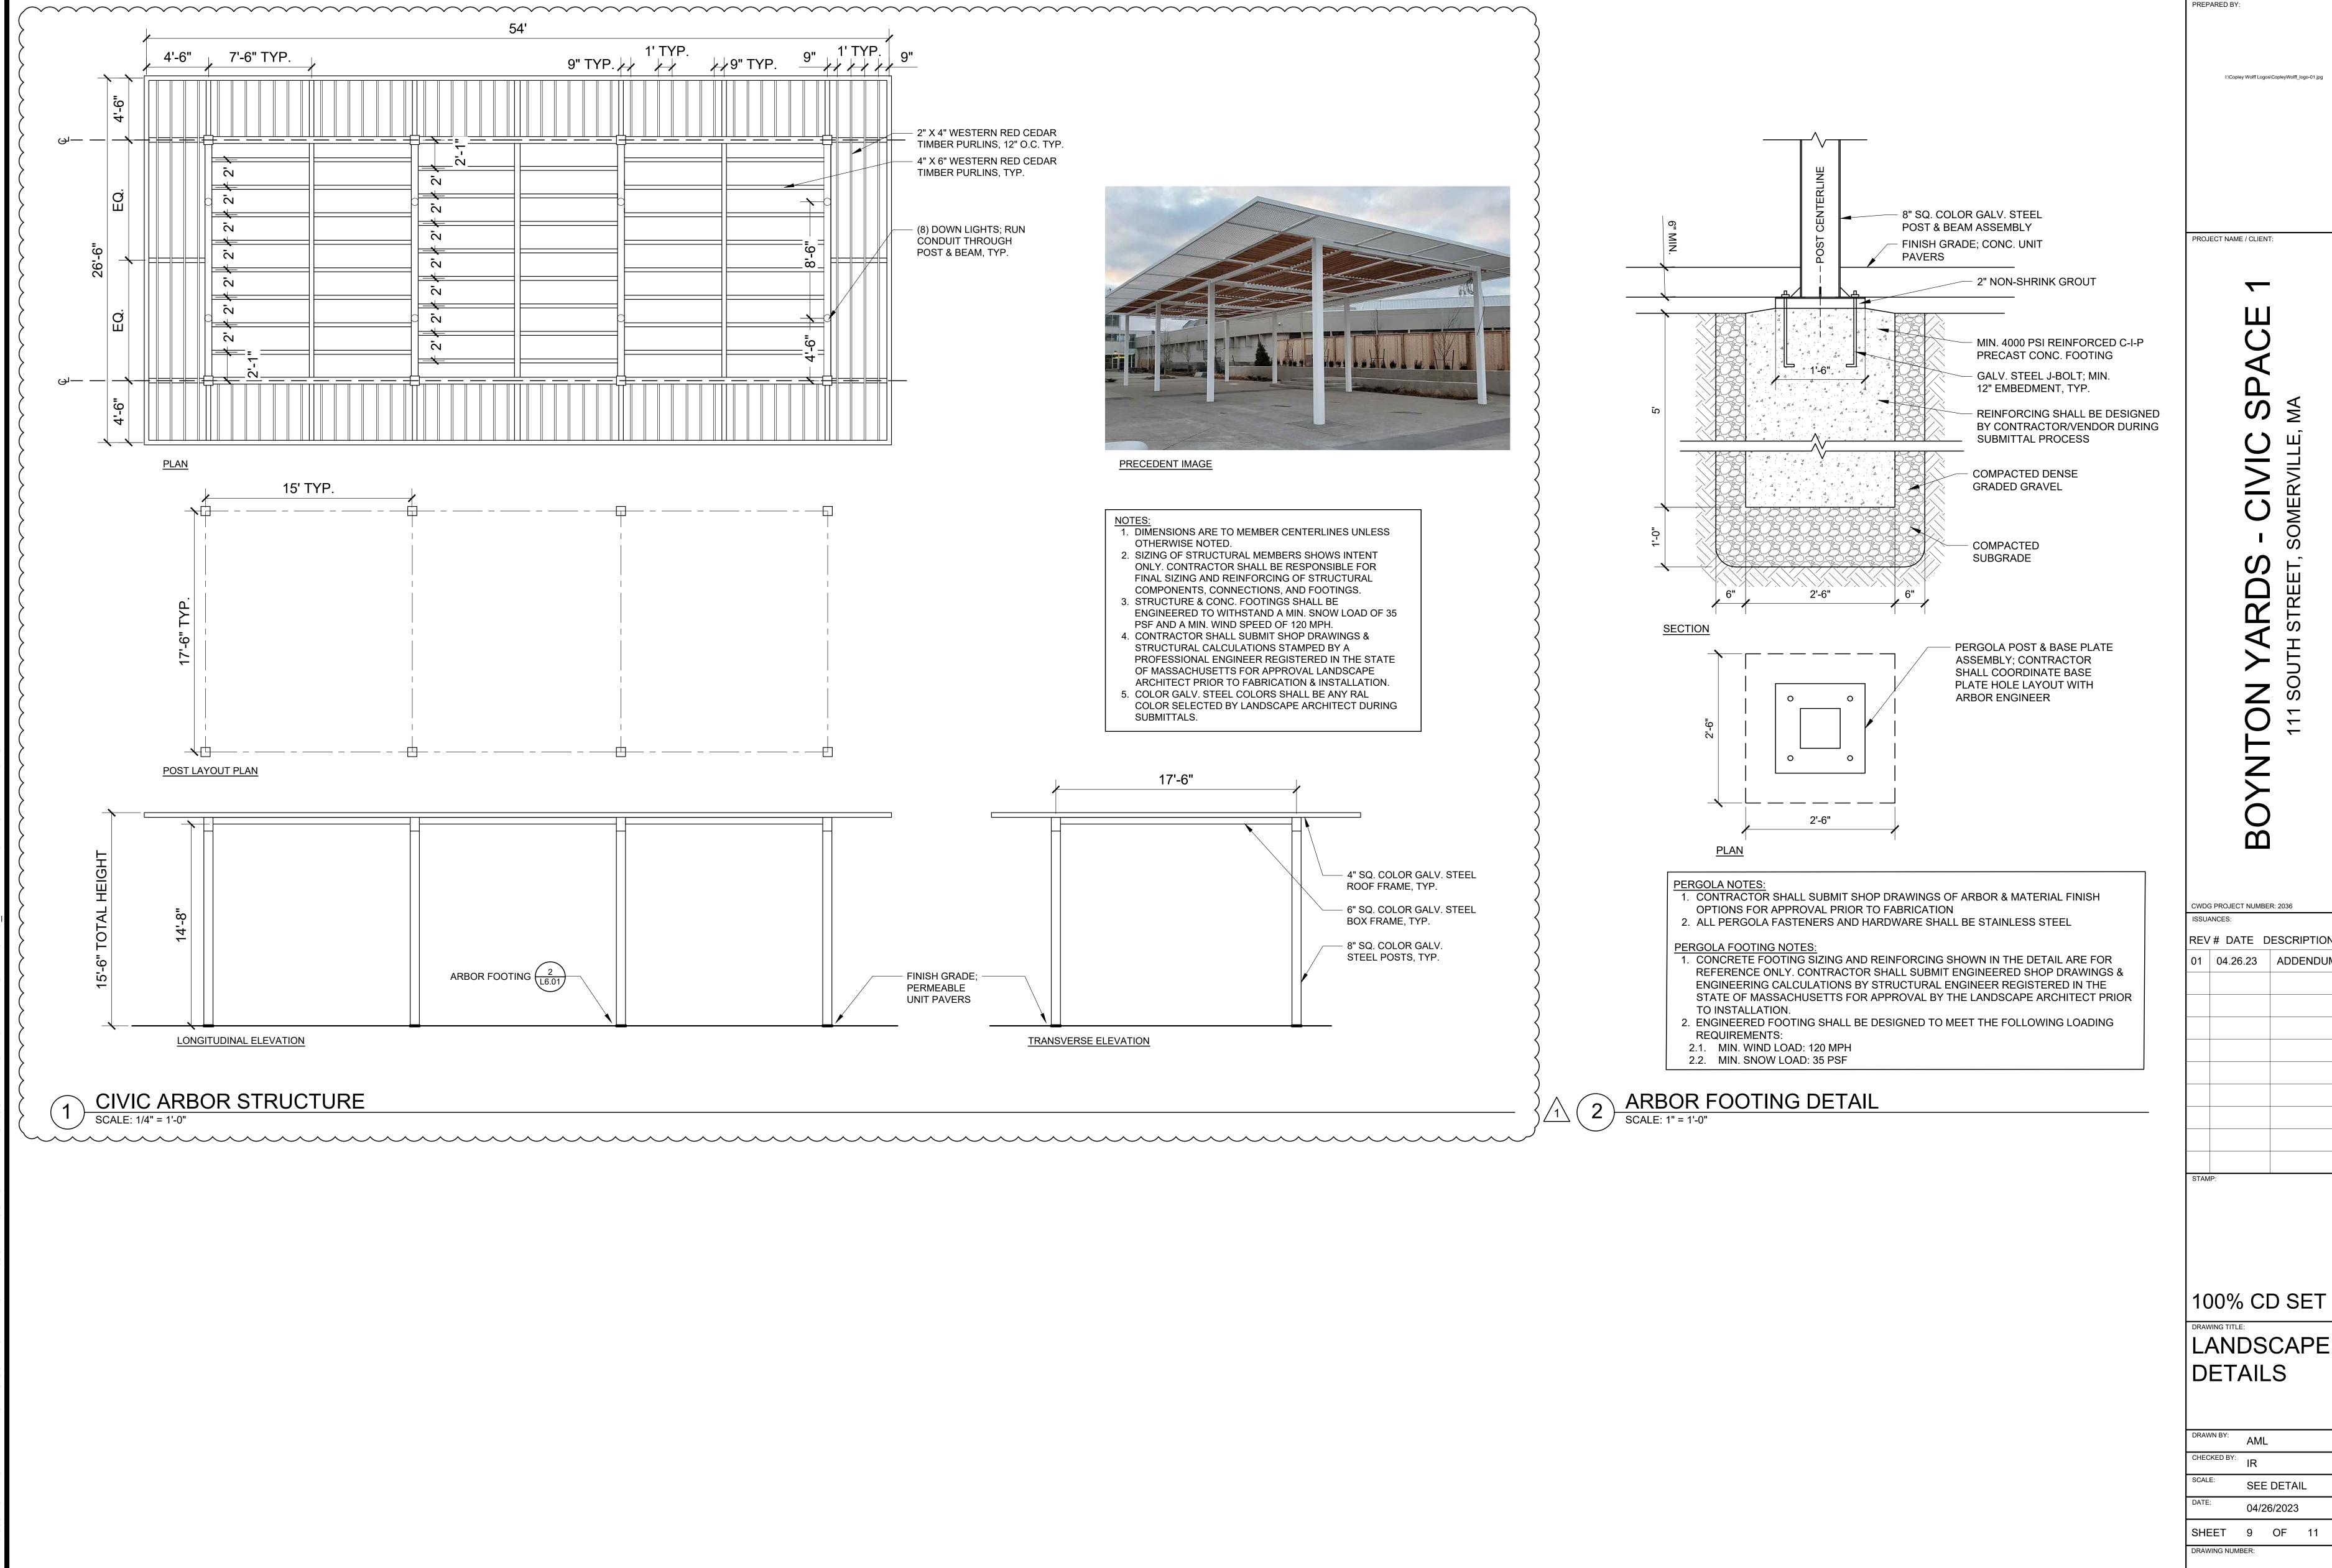01 04.26.23 ADDENDUM #1

LANDSCAPE DETAILS

SEE DETAIL 04/26/2023 SHEET 9 OF 11



1 PARK NAME SIGN

Corner Radius: .5" easement

Size: 18" wide x 18" tall

Colors: Background =PMS 350 (Hunter Green) / Text & Logos= White Text prints frontside only
Sign to be painted green on front, back, and edges.
2 coats primer + 2 coats paint

Stock: 1/4" thick aluminum (same as Park Name sign)



SIGN CONTENT FOR REFERENCE ONLY; -LANDSCAPE ARCHITECT SHALL PROVIDE CONTENT & GRAPHIC FILES TO FABRICATOR

NOTES


NOTES:

1. CONTRACTOR SHALL FURNISH & INSTALL PARK REGULATIONS SIGN(S), POST, MOUNTING BRACKETS, & TAMPERPROOF HARDWARE PER THE CITY OF SOMERVILLE SIGNAGE STANDARDS AND AS SHOWN ON THE PLANS.

- 2. LANDSCAPE ARCHITECT SHALL PROVIDE SIGNAGE FABRICATOR
 WITH PARK REGULATIONS SIGN GRAPHICS FILE(S).
- 3. CONTRACTOR SHALL SUBMIT SHOP DRAWINGS AND FINAL PROOFS OF PARK REGULATIONS SIGN FOR APPROVAL BY THE LANDSCAPE ARCHITECT PRIOR TO FABRICATION & INSTALLATION.

PARK REGULATIONS SIGN



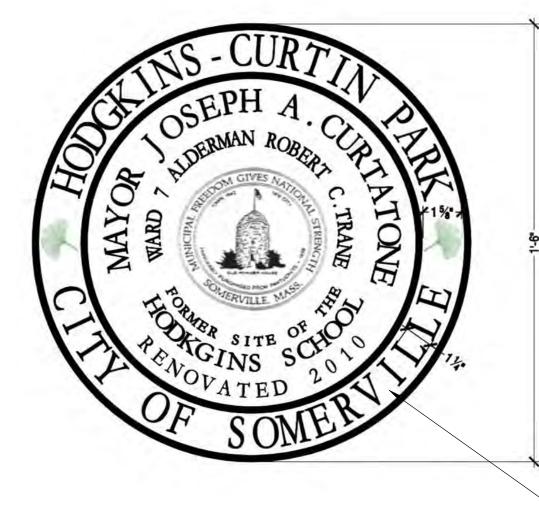

³/₄" THICK, 18" DIA. BRONZE DEDICATION PLAQUE SET ¹/₈" BELOW FINISH GRADE OF SURROUNDING CONCRETE PAVING; CONTENT FOR REFERENCE ONLY; LANDSCAPE ARCHITECT SHALL PROVIDE CONTENT & GRAPHIC FILES TO FABRICATOR

NOTES:


- CONTRACTOR SHALL FURNISH & INSTALL PARK PLAQUE PER THE CITY OF SOMERVILLE SIGNAGE STANDARDS AND AS SHOWN ON THE PLANS.
 LANDSCAPE ARCHITECT SHALL PROVIDE PLAQUE FABRICATOR WITH GRAPHICS FILE(S).
- CONTRACTOR SHALL SUBMIT SHOP DRAWINGS AND FINAL PROOFS OF PARK PLAQUE SIGN FOR APPROVAL BY THE LANDSCAPE ARCHITECT PRIOR TO FABRICATION & INSTALLATION.
- 4. CONTRACTOR SHALL SUBMIT SHOP DRAWING FOR APPROVAL BY LANDSCAPE ARCHITECT SHOWING APPROPRIATE SETTING HARDWARE.

PARK PLAQUE

live

- NO PRUNING SHALL BE PERFORMED EXCEPT BY APPROVED

 ARBORIST
- NO EQUIPMENT SHALL OPERATE INSIDE PROTECTIVE FENCING INCLUDING DURING FENCE INSTALLATION AND REMOVAL.

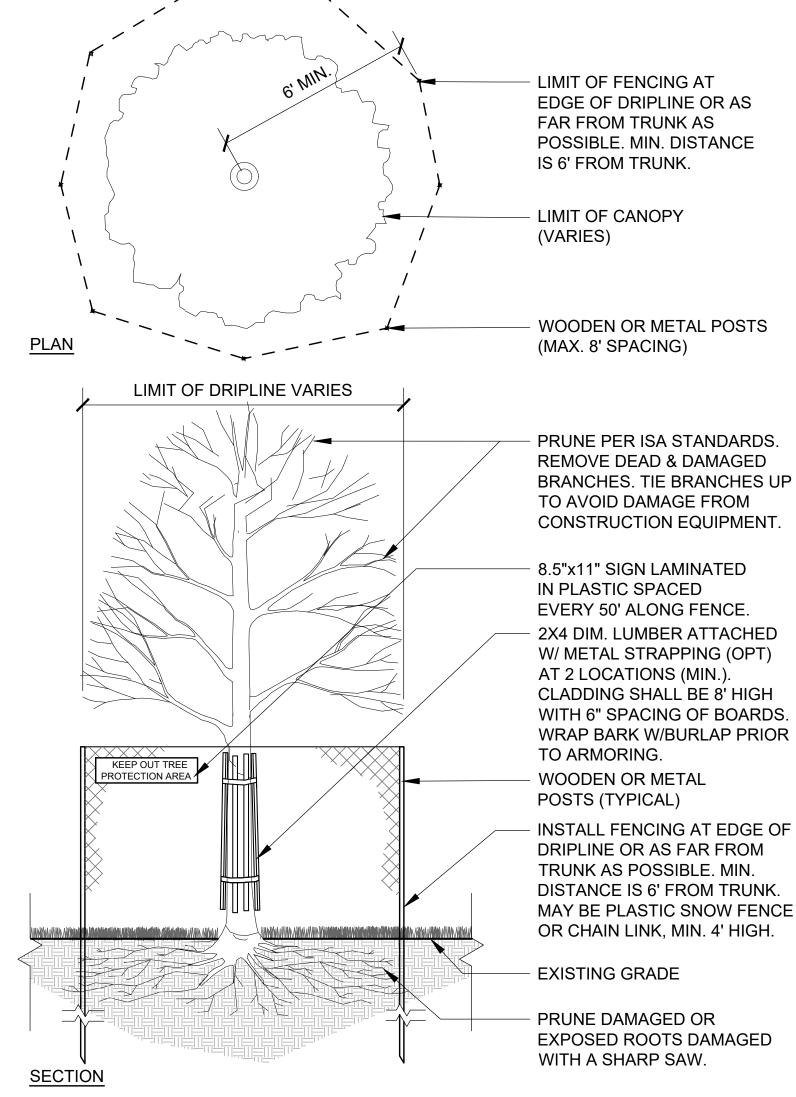

TREE PROTECTION SOFTSCAPE

SCALE: 1/2" = 1'-0"

Copley Wolff

PROJECT NAME / CLIENT:

PREPARED BY:

RDS - CIVIC SPACE

CWDG PROJECT NUMBER: 2036
ISSUANCES:

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REV # DATE DESCRIPTION

100% CD SET

LANDSCAPE DETAILS

DRAWN BY:

SCALE: SEE DETAIL

DATE: 03/10/2023


SHEET 10 OF 11


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TRASH/RECYCLING RECEPTACLE

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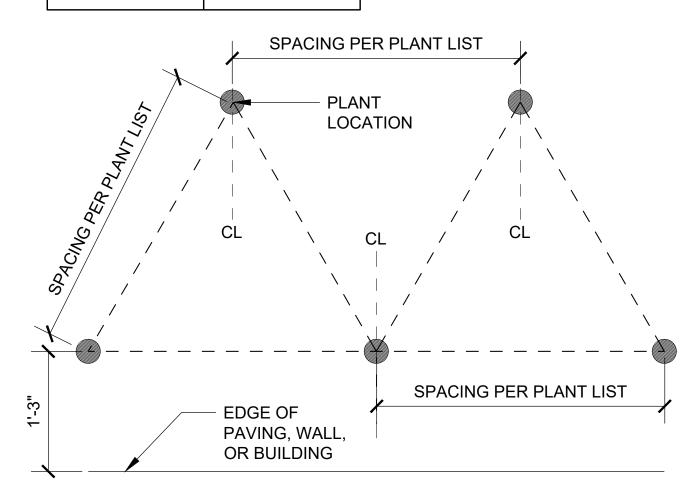




PLANT SPACING:	# OF PLANTS / SF
8"	2.6
12"	1.15
15"	.733
18"	.512
36"	.128
48"	.0725

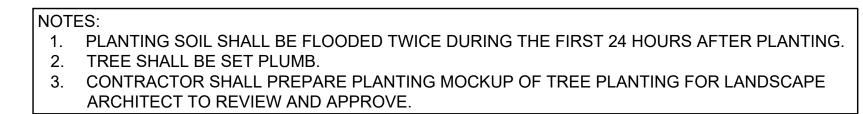1 TREE PLANTING DECIDUOUS

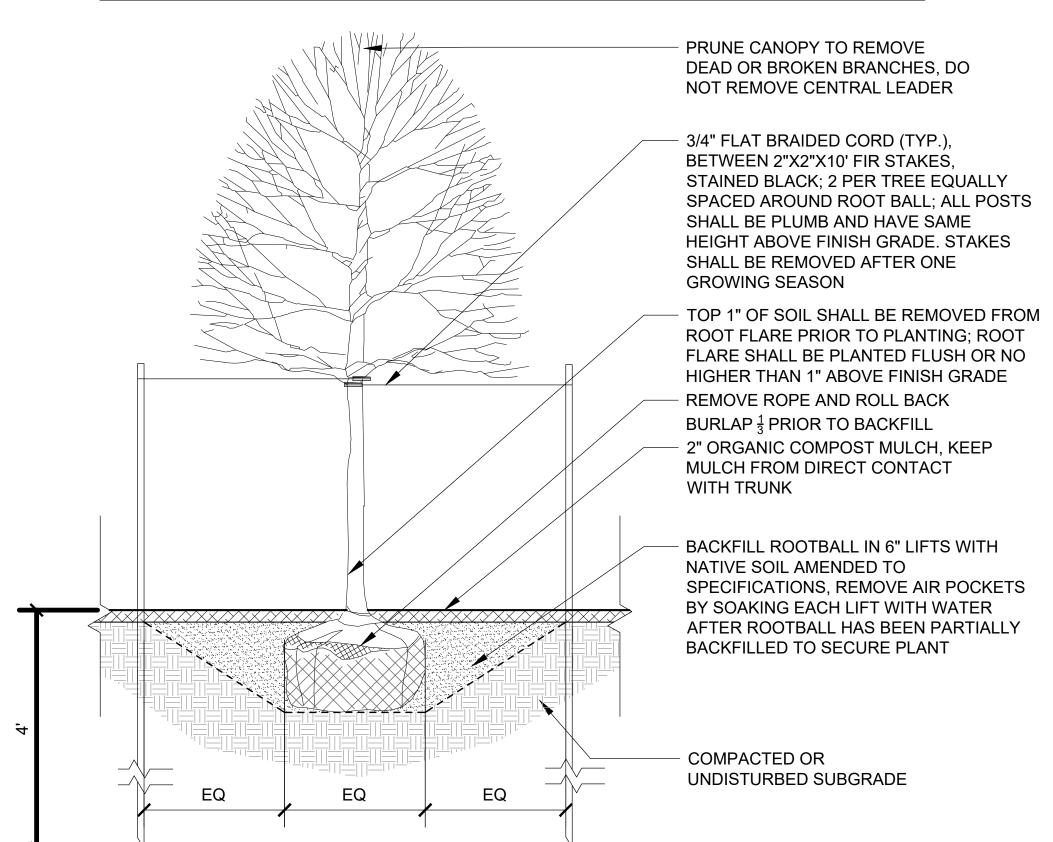
SCALE: 3/4" = 1'-0"



PLANT LAYOUT DIAGRAM


SCALE: 1" = 1'-0"

NOTE:
1. SEE PLANTING LAYOUT DETAIL FOR SPACING AND LAYOUT.

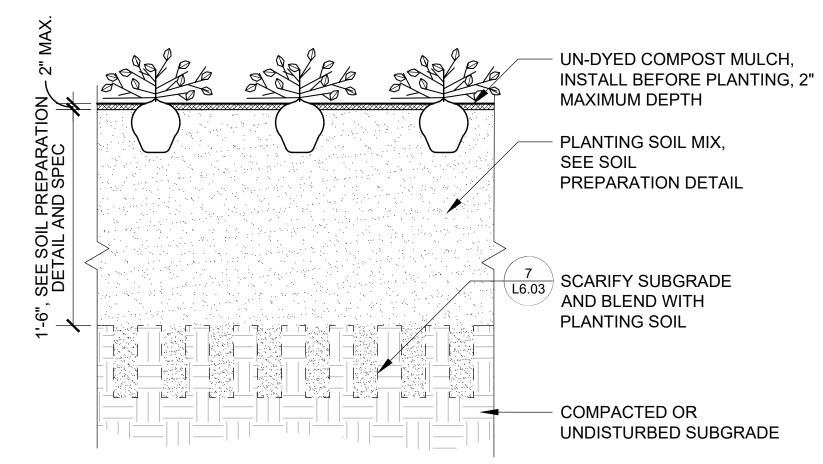


9 PERENNIAL / GROUNDCOVER PLANTING
SCALE: 1-1/2" = 1'-0"


NOTE:
1. SHOP DRAWINGS REQUIRED PRIOR TO INSTALLATION.

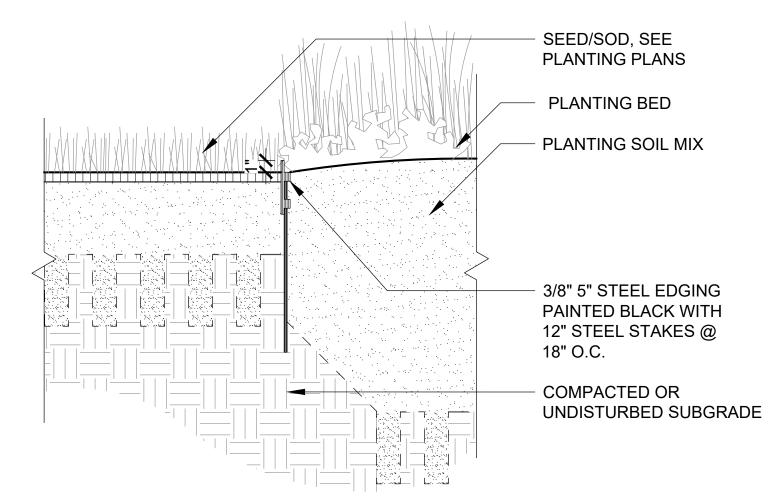

4 PLANTING EDGING AT PLANT BED

SCALE: 1-1/2" = 1'-0"

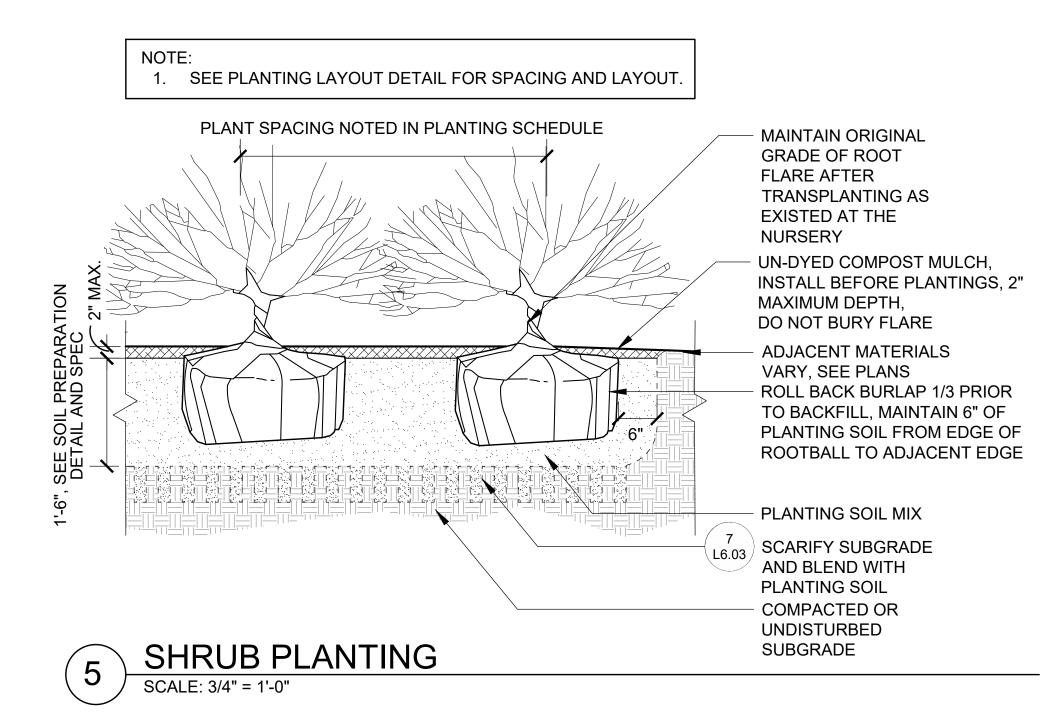

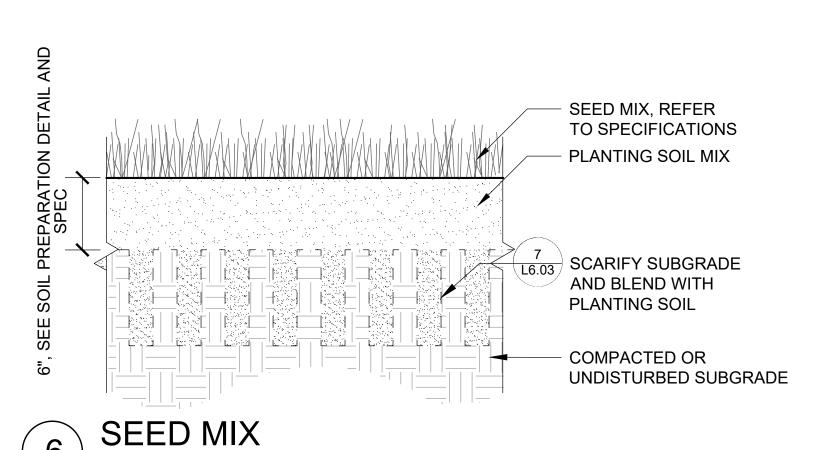

SCALE: 1-1/2" = 1'-0"

PLANT SOIL BACKFILL
MIX ABOVE
TRANSITIONAL LAYER

SCARIFY SUBGRADE AND
BLEND WITH PLANTING SOIL
PER SPECIFICATIONS TO
MINIMUM 12" DEPTH
COMPACTED OR
UNDISTURBED SUBGRADE

7 SOIL PREPARATION GROUNDCOVER AND SHRUBS
SCALE: 1-1/2" = 1'-0"

Copley Wolff

PREPARED BY:

PROJECT NAME / CLIENT:

NTON YARDS - CIVIC SPACE

CWDG PROJECT NUMBER: 2036 ISSUANCES:						
REV # DATE DESCRIPTION						
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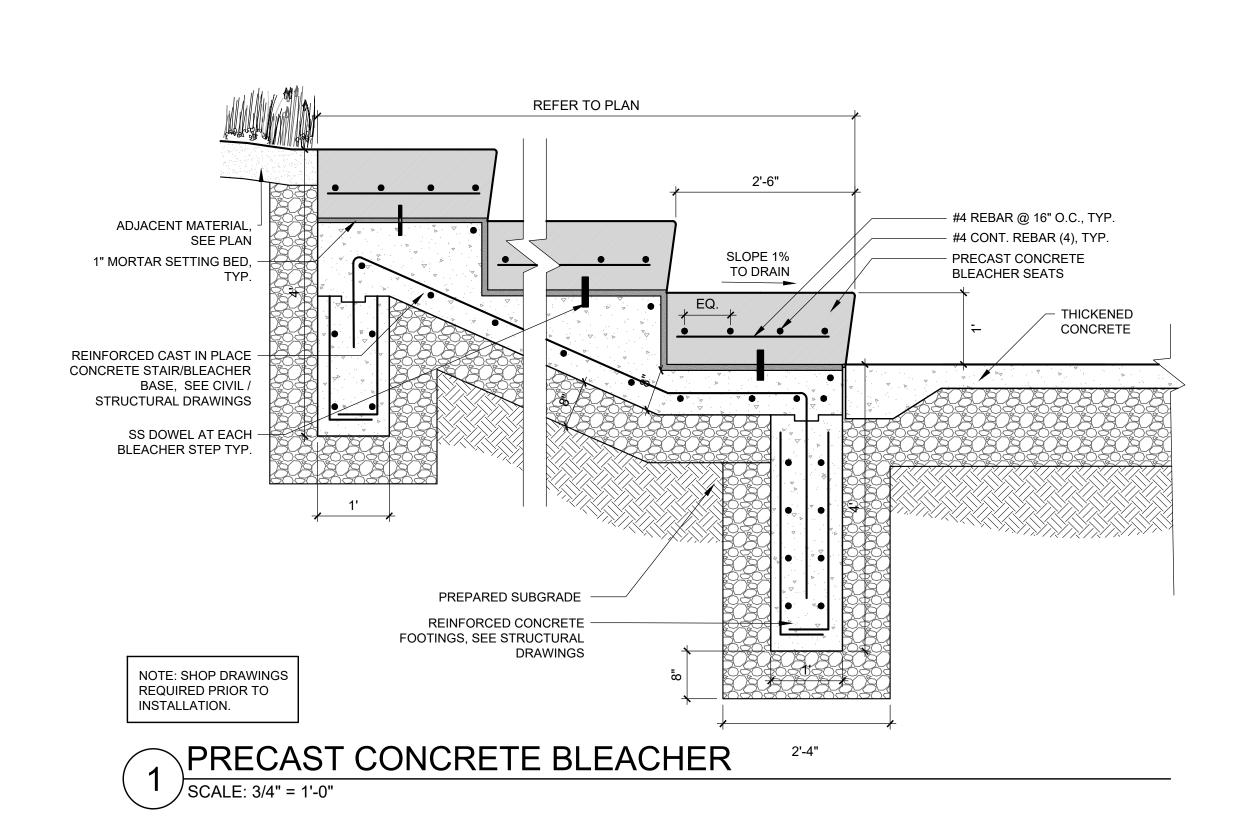
LANDSCAPE DETAILS


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SHEET	11	OF	11

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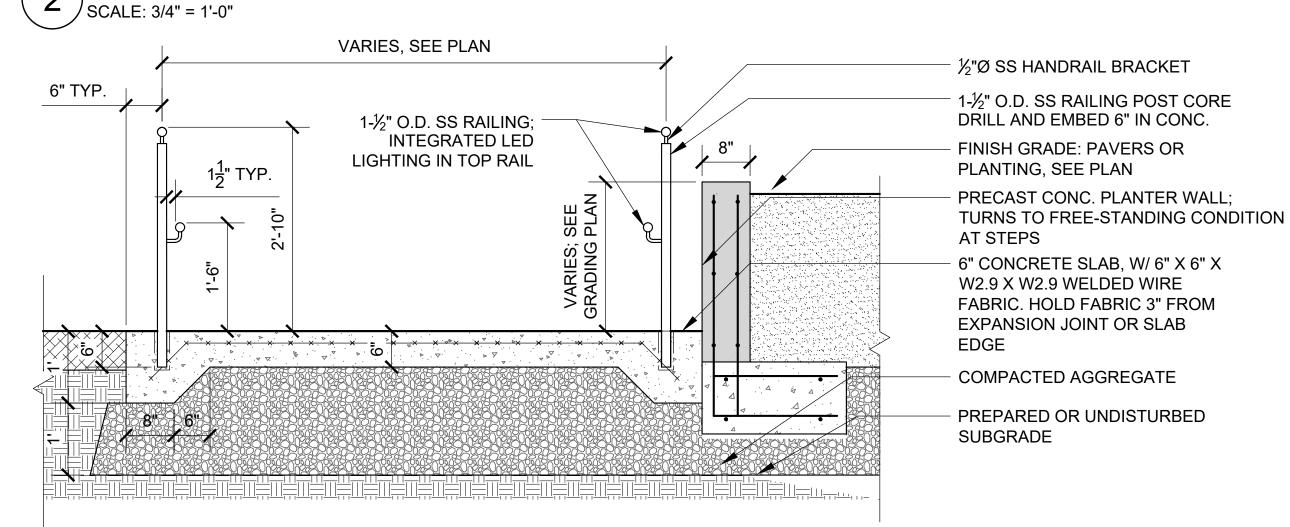






CONCRETE RAMP

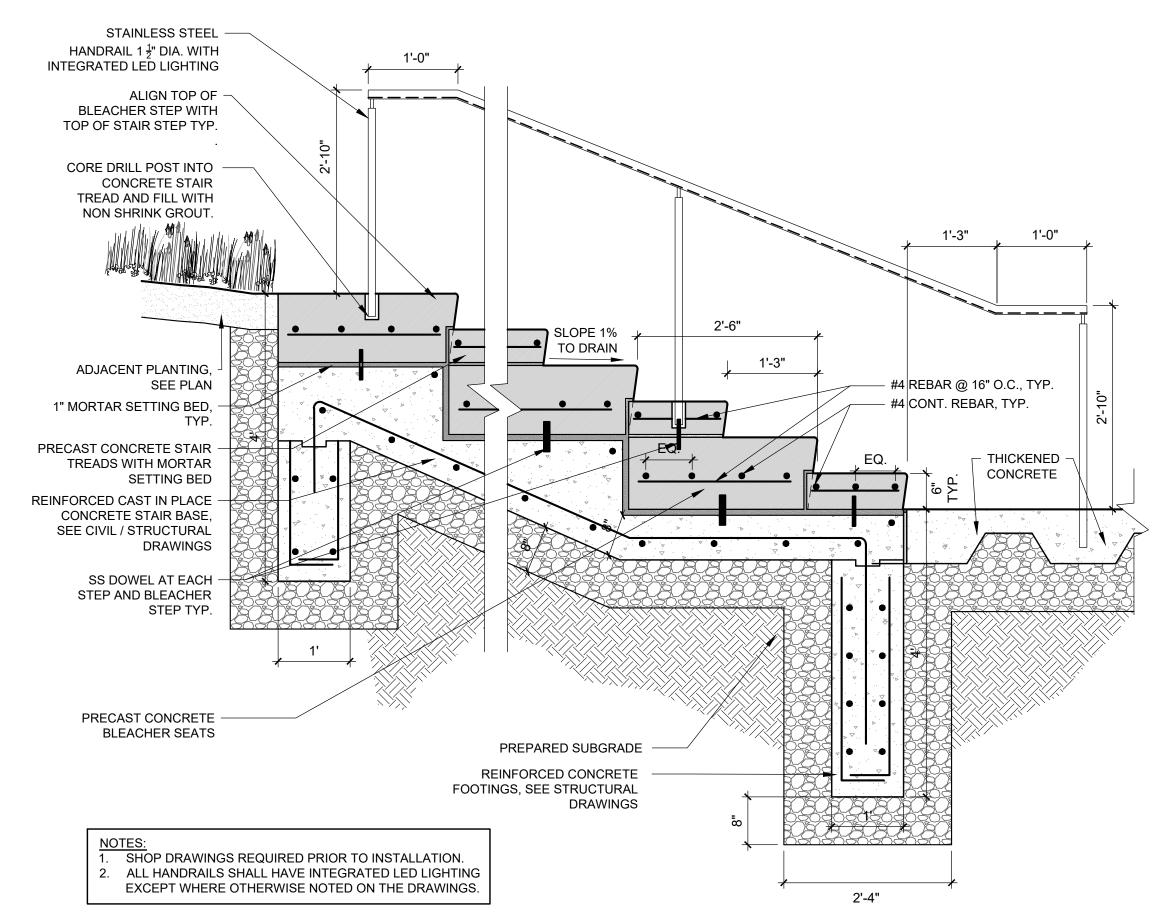SCALE: 3/4" = 1'-0"





NOTES:

1. SHOP DRAWINGS REQUIRED.

2. HANDRAIL TO BE STAINLESS STEEL.

2. ALL HANDRAILS SHALL HAVE INTEGRATED LED LIGHTING EXCEPT WHERE OTHERWISE NOTED ON THE DRAWINGS.

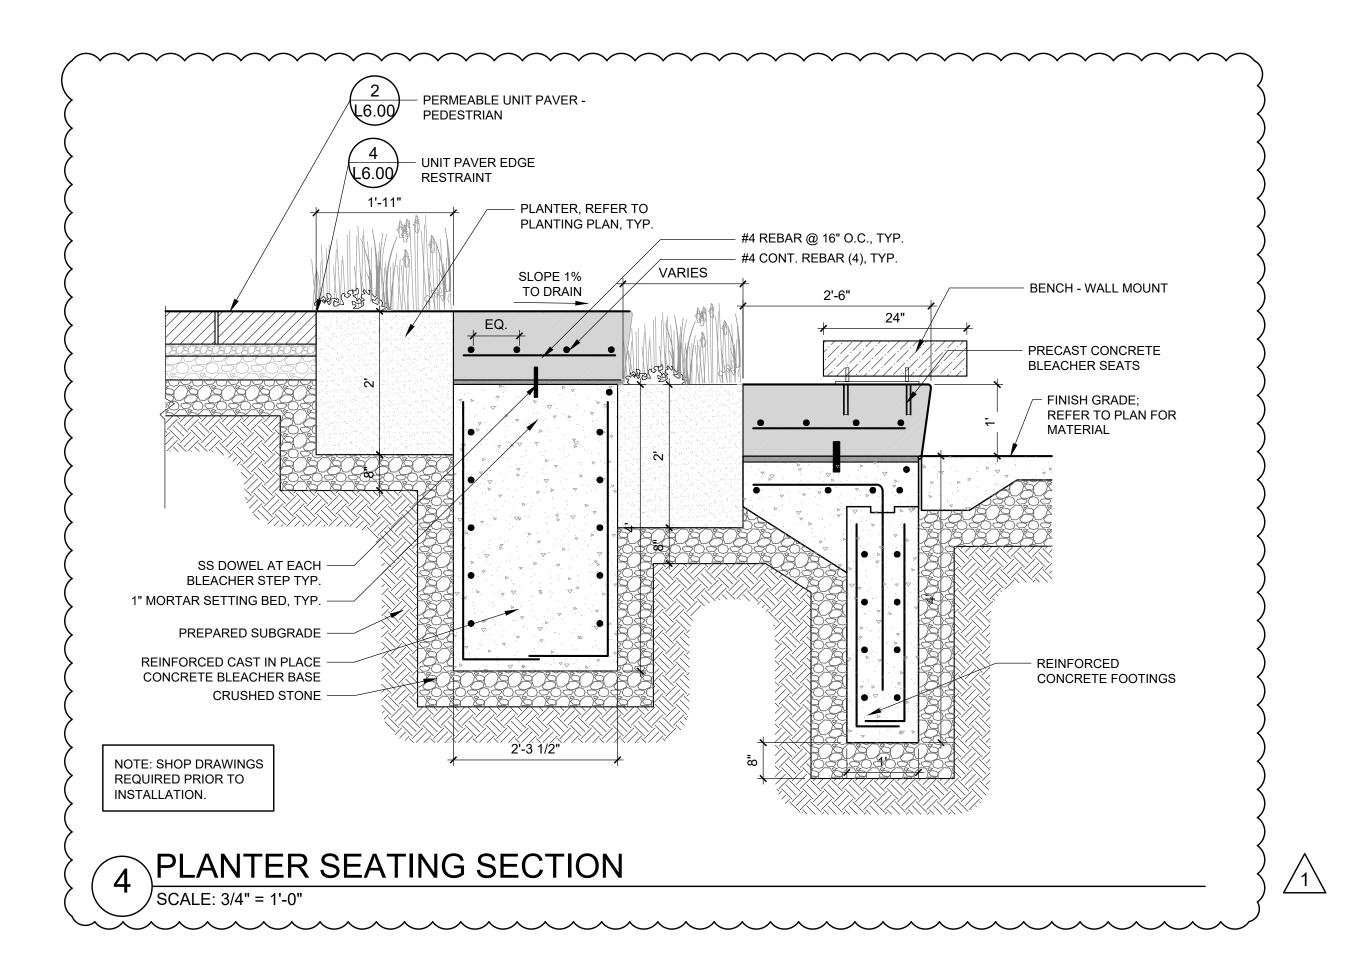

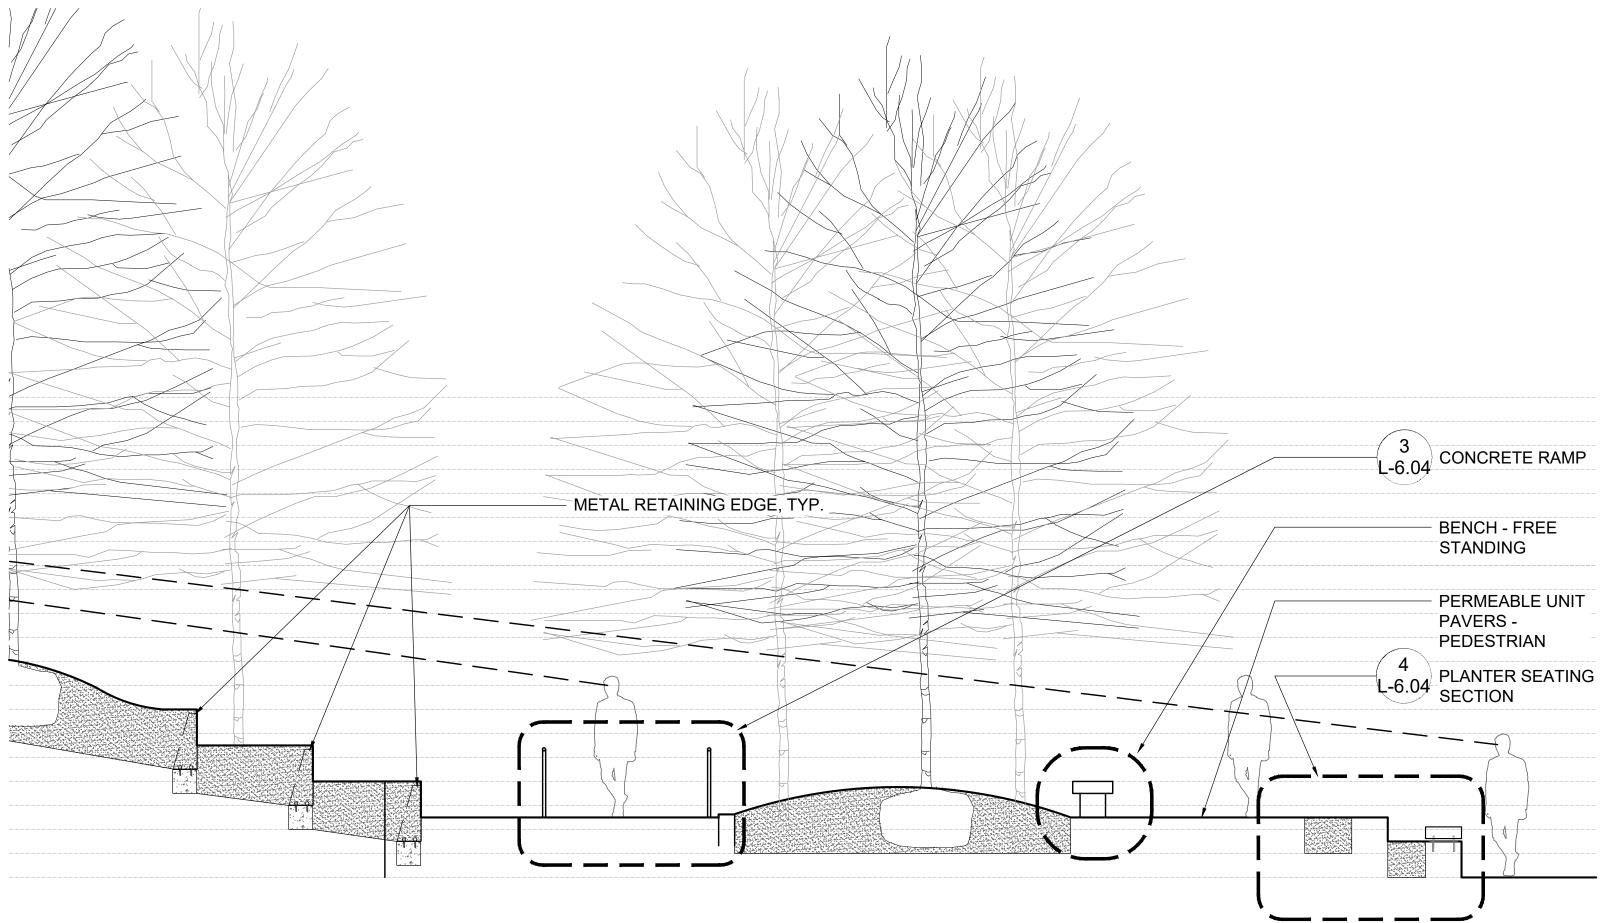

5 CIVIC PLATFORM SECTION

SCALE: 1/4" = 1'-0"

CIVIC PLATFORM DETAIL NOTES:

1. CIVIC PLATFORM DETAILS INCLUDED
FOR REFERENCE ONLY.
2. CIVIC PLATFORM BEING

WINDSOR PROJECT.

CONSTRUCTED AS PART OF 808

LS INCLUDED

I:\Copley Wolff Logos\CopleyWolff_logo-01.jpg

PREPARED BY:

PROJECT NAME / CLIENT:

N YARDS - CIVIC SPACE

ISSUANCES:

REV # DATE DESCRIPTION

01 04.26.23 ADDENDUM #1

100% CD SET

CIVIC PLATFORM DETAILS

CHECKED BY: IR

SCALE: SEE DETAIL


DATE: 04/26/2023

SHEET 11 OF 11

DRAWING NUMBER:

DRAWN BY:

L6.04

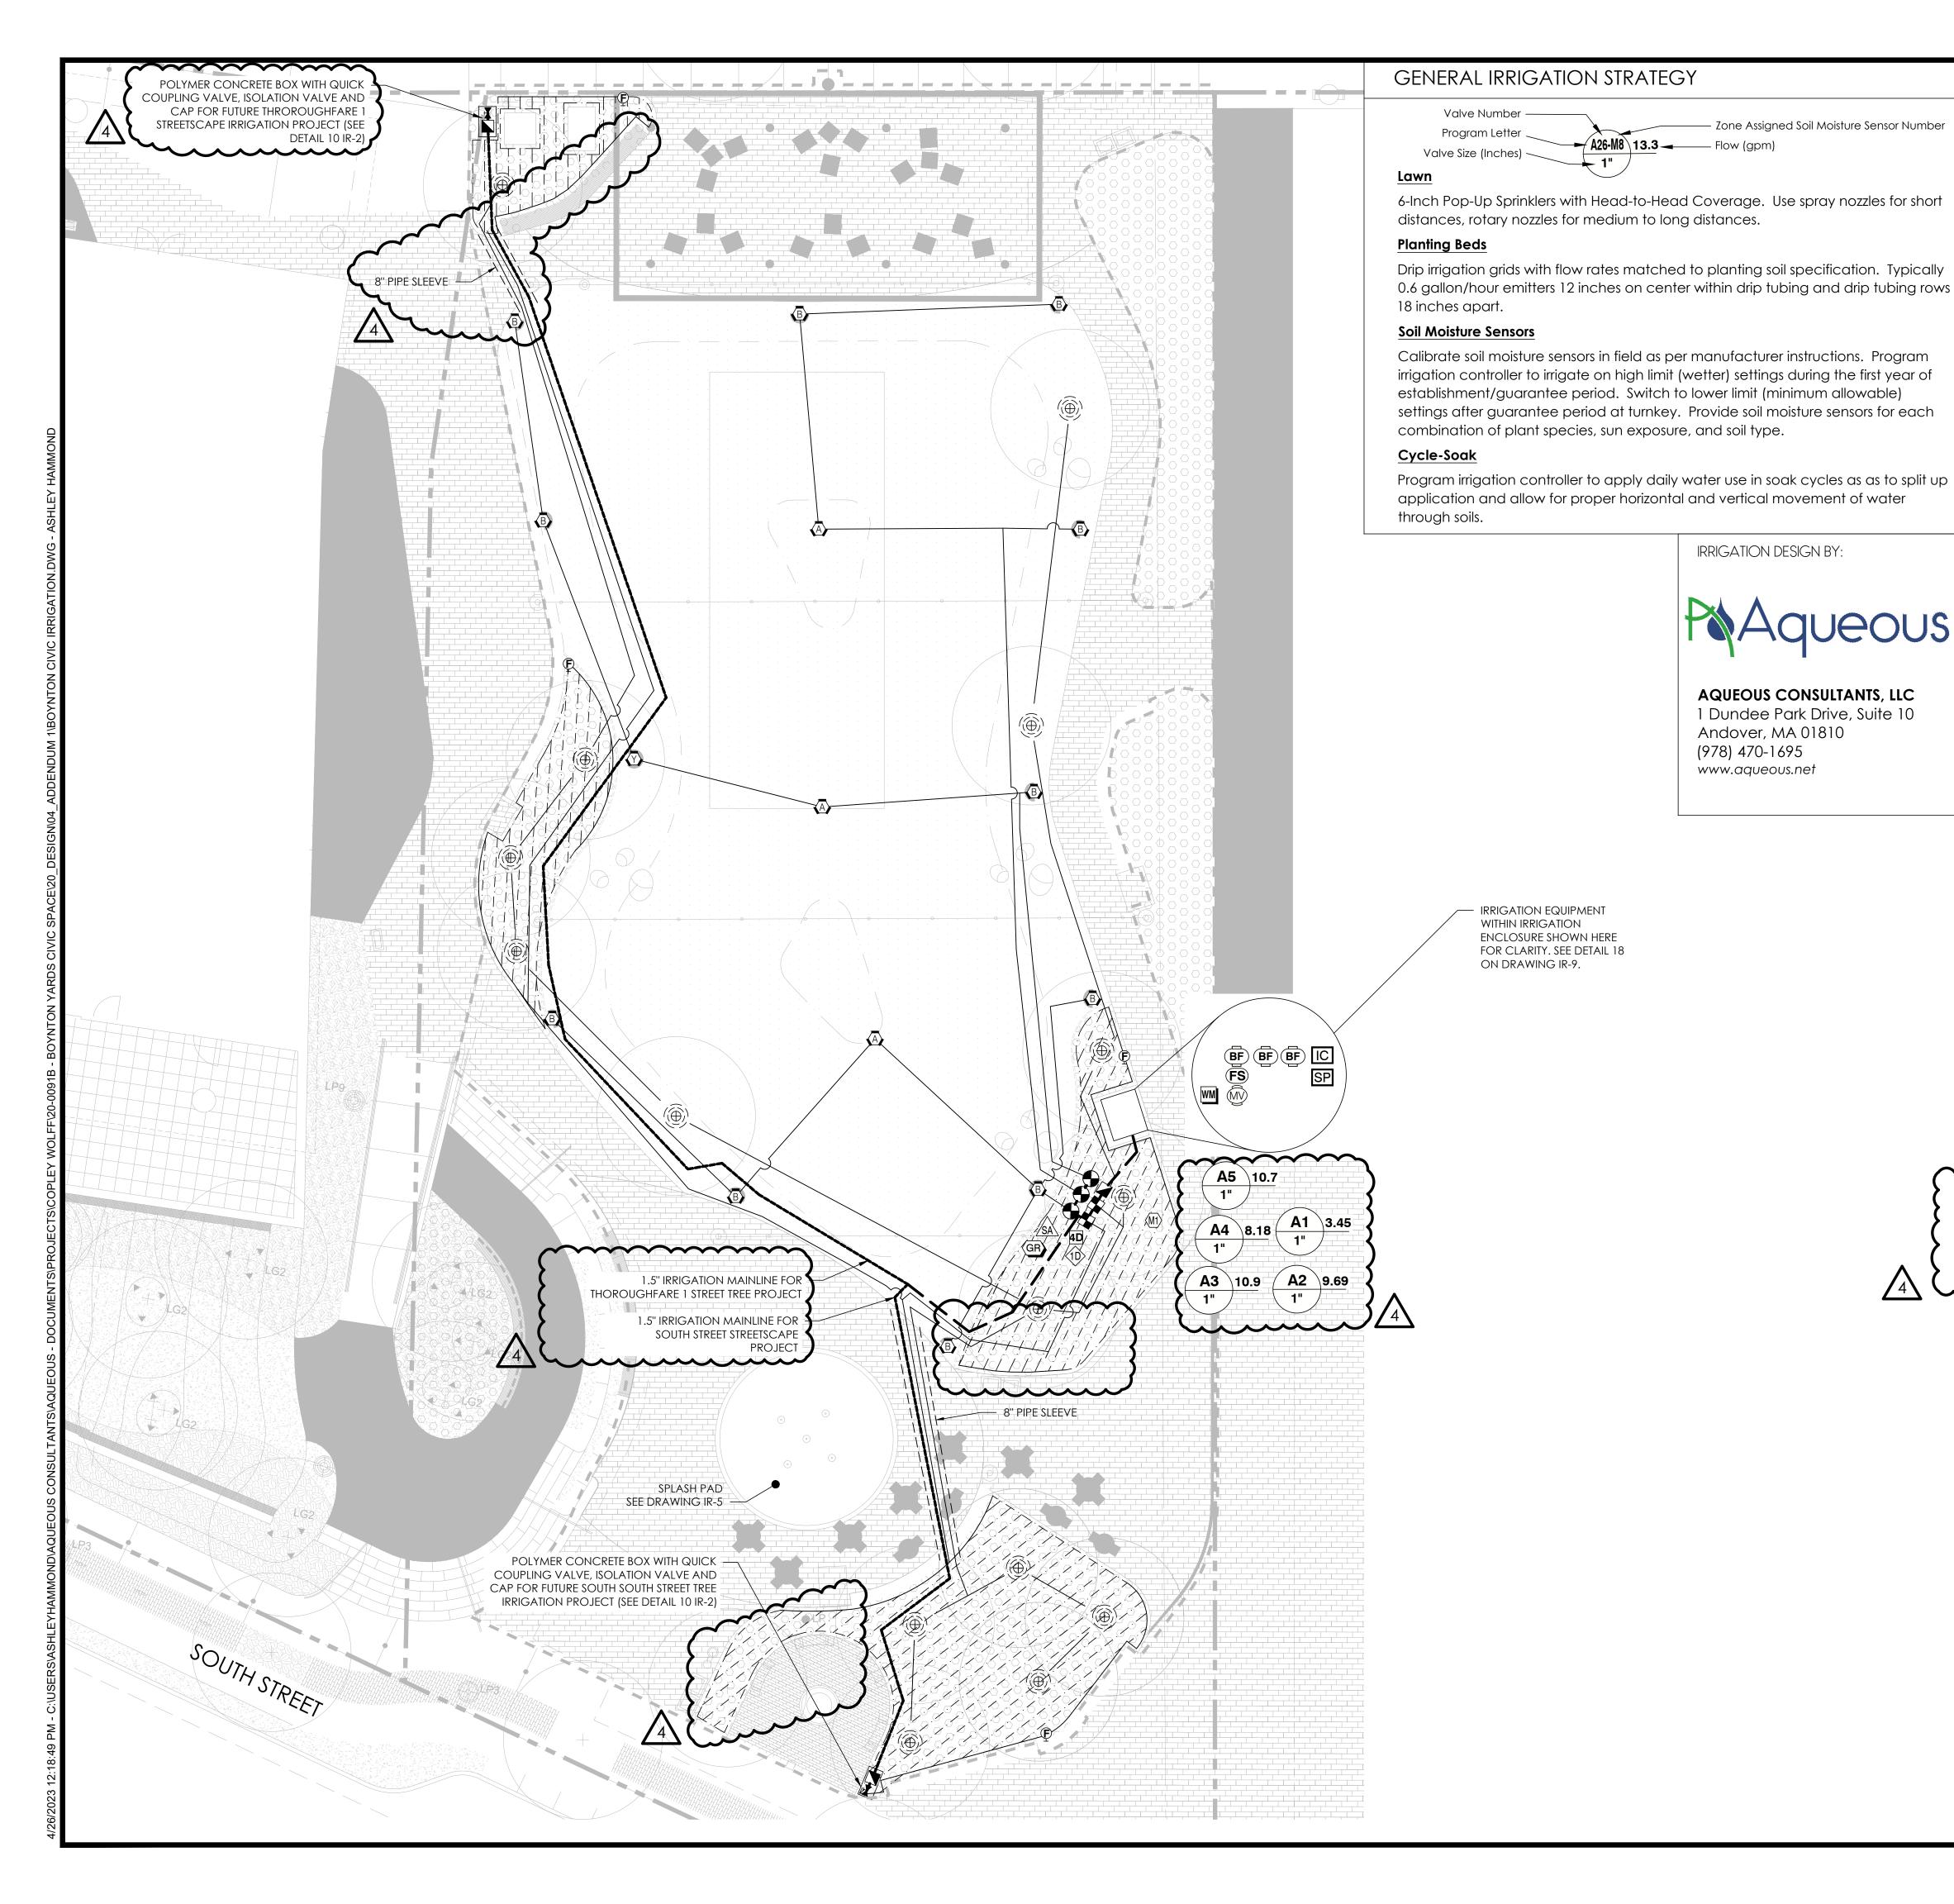

IRRIGATION NOTES

- SEE IRRIGATION DETAILS AND SPECIFICATIONS SECTION 328400 FOR ADDITIONAL REQUIRED INFORMATION. SEE LANDSCAPE PLANS FOR ADDITIONAL INFORMATION. Zone Assigned Soil Moisture Sensor Number
 - COORDINATE FINAL LOCATION OF IRRIGATION AND VALVE BOXES WITH FINAL APPROVED LANDSCAPE. IN GENERAL, PLACE ALL VALVE BOXES WITHIN PLANTER BEDS TO MAXIMUM EXTENT PRACTICABLE FOR AT-GRADE LANDSCAPE.
 - ALL PIPE AND VALVE LOCATIONS ARE DIAGRAMMATIC FOR CLARITY: CONTRACTOR SHALL FIELD VERIFY. SPECIFIED VALVE BOX LOCATIONS AND COLORS SHALL BE APPROVED BY LANDSCAPE ARCHITECT AND/OR
 - OWNER'S REPRESENTATIVE.
 - ALL CONTROL WIRE SHALL BE 14/2 AWG TWO-WIRE INSTALLED PARALLEL TO MAINLINE DIRECT BURIAL WITH DBY/R-6 WIRE SPLICE KITS.
 - IRRIGATION SYSTEM IS DESIGNED FOR DOMESTIC WATER SUPPLY AT 12 GPM MAXIMUM. SYSTEM TO PRODUCE 60-PSI DYNAMIC PRESSURE MINIMUM AT EACH AT-GRADE IRRIGATION POINT OF CONNECTION. CONTRACTOR SHALL TEST DYNAMIC PRESSURE BEFORE STARTING WORK AND REPORT ANY DEVIATION TO THE OWNER'S REPRESENTATIVE BEFORE CONTINUING.
 - INSTALL NEW CONTROLLER IN IRRIGATION ENCLOSURE AS LOCATED APPROXIMATELY ON PLANS, AS DIRECTED BY OWNER'S REPRESENTATIVE. HARD WIRE TO 120 VOLT, DEDICATED 20-AMP CIRCUIT, POWER SUPPLY USING LICENSED ELECTRICIAN TO IRRIGATION CONTROLLER. PROVIDE CELLULAR COMMUNICATIONS FOR IRRIGATION CONTROLLER.
 - GROUND IRRIGATION CONTROLLER TO APPROVED GROUNDING ROD LOCATION. COORDINATE WITH SITE
 - GROUND ALL DECODERS IN THE FIELD BY CONNECTING SURGE ARRESTORS TO BARE COPPER 6AWG WIRE BACK TO GROUNDING RODS AS REQUIRED BY MANUFACTURER.
 - . COORDINATE LOCATION OF ALL EXISTING AND FUTURE UTILITIES ON SITE, CONTACT PROPER AUTHORITIES
 - AND UTILITY COMPANIES BEFORE THE START OF WORK. FLUSH ALL LATERAL LINES BEFORE INSTALLING SPRINKLER AND DRIP IRRIGATION WITH DOMESTIC WATER.
 - CONTRACTOR MUST SUBMIT PRODUCT CUT SHEETS AS PER THE WRITTEN SPECIFICATIONS TO THE ENGINEER FOR APPROVAL PRIOR TO ORDERING MATERIAL AND BEGINNING WORK.
 - 13. MATERIAL SUBSTITUTIONS WHICH VARY FROM THE SPECIFIED PRODUCTS MUST BE SUBMITTED TO THE ENGINEER FOR APPROVAL AS PART OF THE SUBMITTAL PROCESS.
 - 14. ONCE APPROVED SUBMITTALS HAVE BEEN RETURNED TO THE CONTRACTOR, WORK MAY BEGIN. OWNER'S REPRESENTATIVE MUST BE NOTIFIED 7 DAYS IN ADVANCE OF THE START OF WORK TO COORDINATE ON-SITE SUPERVISION AND ADMINISTRATION.

IRRICATION MATERIAL LIST

ELECTRICAL CONTRACTOR.

IRRIGATION DESIGN BY:

AQUEOUS CONSULTANTS, LLC 1 Dundee Park Drive, Suite 10

Andover, MA 01810

(978) 470-1695 www.aqueous.net

19	IRRIGATION I	MATERIAL LIST	
	SYMBOL	MANUFACTURER/MODEL	DETAIL # (IR-2)
	IC	Landscape Irrigaiton Controller Baseline BaseStation3200 with BaseManager 2.0	1, 2
	SP	Splash Pad Controllers	19 (IR-9)
	(M1)	Soil Moisture Sensor with Number	4
	√1D>	1-Station Decoder	2, 5
	4D	4-Station Decoder	2 , 3
	SA	Surge Arrestor	3
	GR	Decoder Grounding Rod	5
	•	Commercial Electric Zone Valve w/Sentry/Scrubber	7
		1-Inch Drip Control Zone Kit (Filter, PR)	8
		Quick Coupler Valve	9
	×	1-Inch Isolation Gate Valve with Cross Handle	10
	SYMBOL	MANUFACTURER/MODEL	DETAIL # (IR-3)
	Φ	Automatic Flush Valve	11
		Planted Area and Trees to Receive Dripline 0.6 gph Emitters 12" O.C. at 18" Row Spacing	12
	(1)	Tree/Shrub Rings with 0.9 gph Emitter 12" O.C. at 2' and 3' Diameter Centered on Trunk/Root Ball	13
		_ Irrigation Lateral Line: PVC Schedule 40 Size as Noted, Unlabled Pipe = 1-Inch	
	~~~~	Irrigation Mainline: 2-Inch PVC Schedule 40	14
<b>\</b>		rrigation Mainline: 1.5-Inch PVC Sch. 40 (Future Work)	}
<b>\</b>		Pipe Sleeve: PVC SDR 35 Solvent Weld (with Size)	3 15
<b>\</b>	BYA	6" Pop-Up Rotary Sprinkler w/CV PR40 (Large)	16
, ~	FS	2 Inch Brass Flow Sensor	

1, 1.5, 2 RPZ Backflow Preventer

IRRIGATION LAYOUT PLAN

Scale 1" = 10'

2 Inch Brass Master Valve

Water Meter

**Copley Wolff Design Group** Landscape Architects & Planners

PROJECT NAME / CLIENT:

CWDG PROJECT NUMBER: 2036,000

REV # DATE DESCRIPTION 1 | 12.15.2020 BULLETIN 47


2 10.07.2022 90% CONSTRUCTION DOCUMENTS 3 3.10.2023 100% CONSTRUCTION DOCUMENTS 4 4.26.2023 ADDENDUM NO. 1

18 (IR-9)

IRRIGATION LAYOUT PLAN

CHECKED BY: 1" = 10' 3.10.23

SHEET 1 OF 10 RAWING NUMBER:

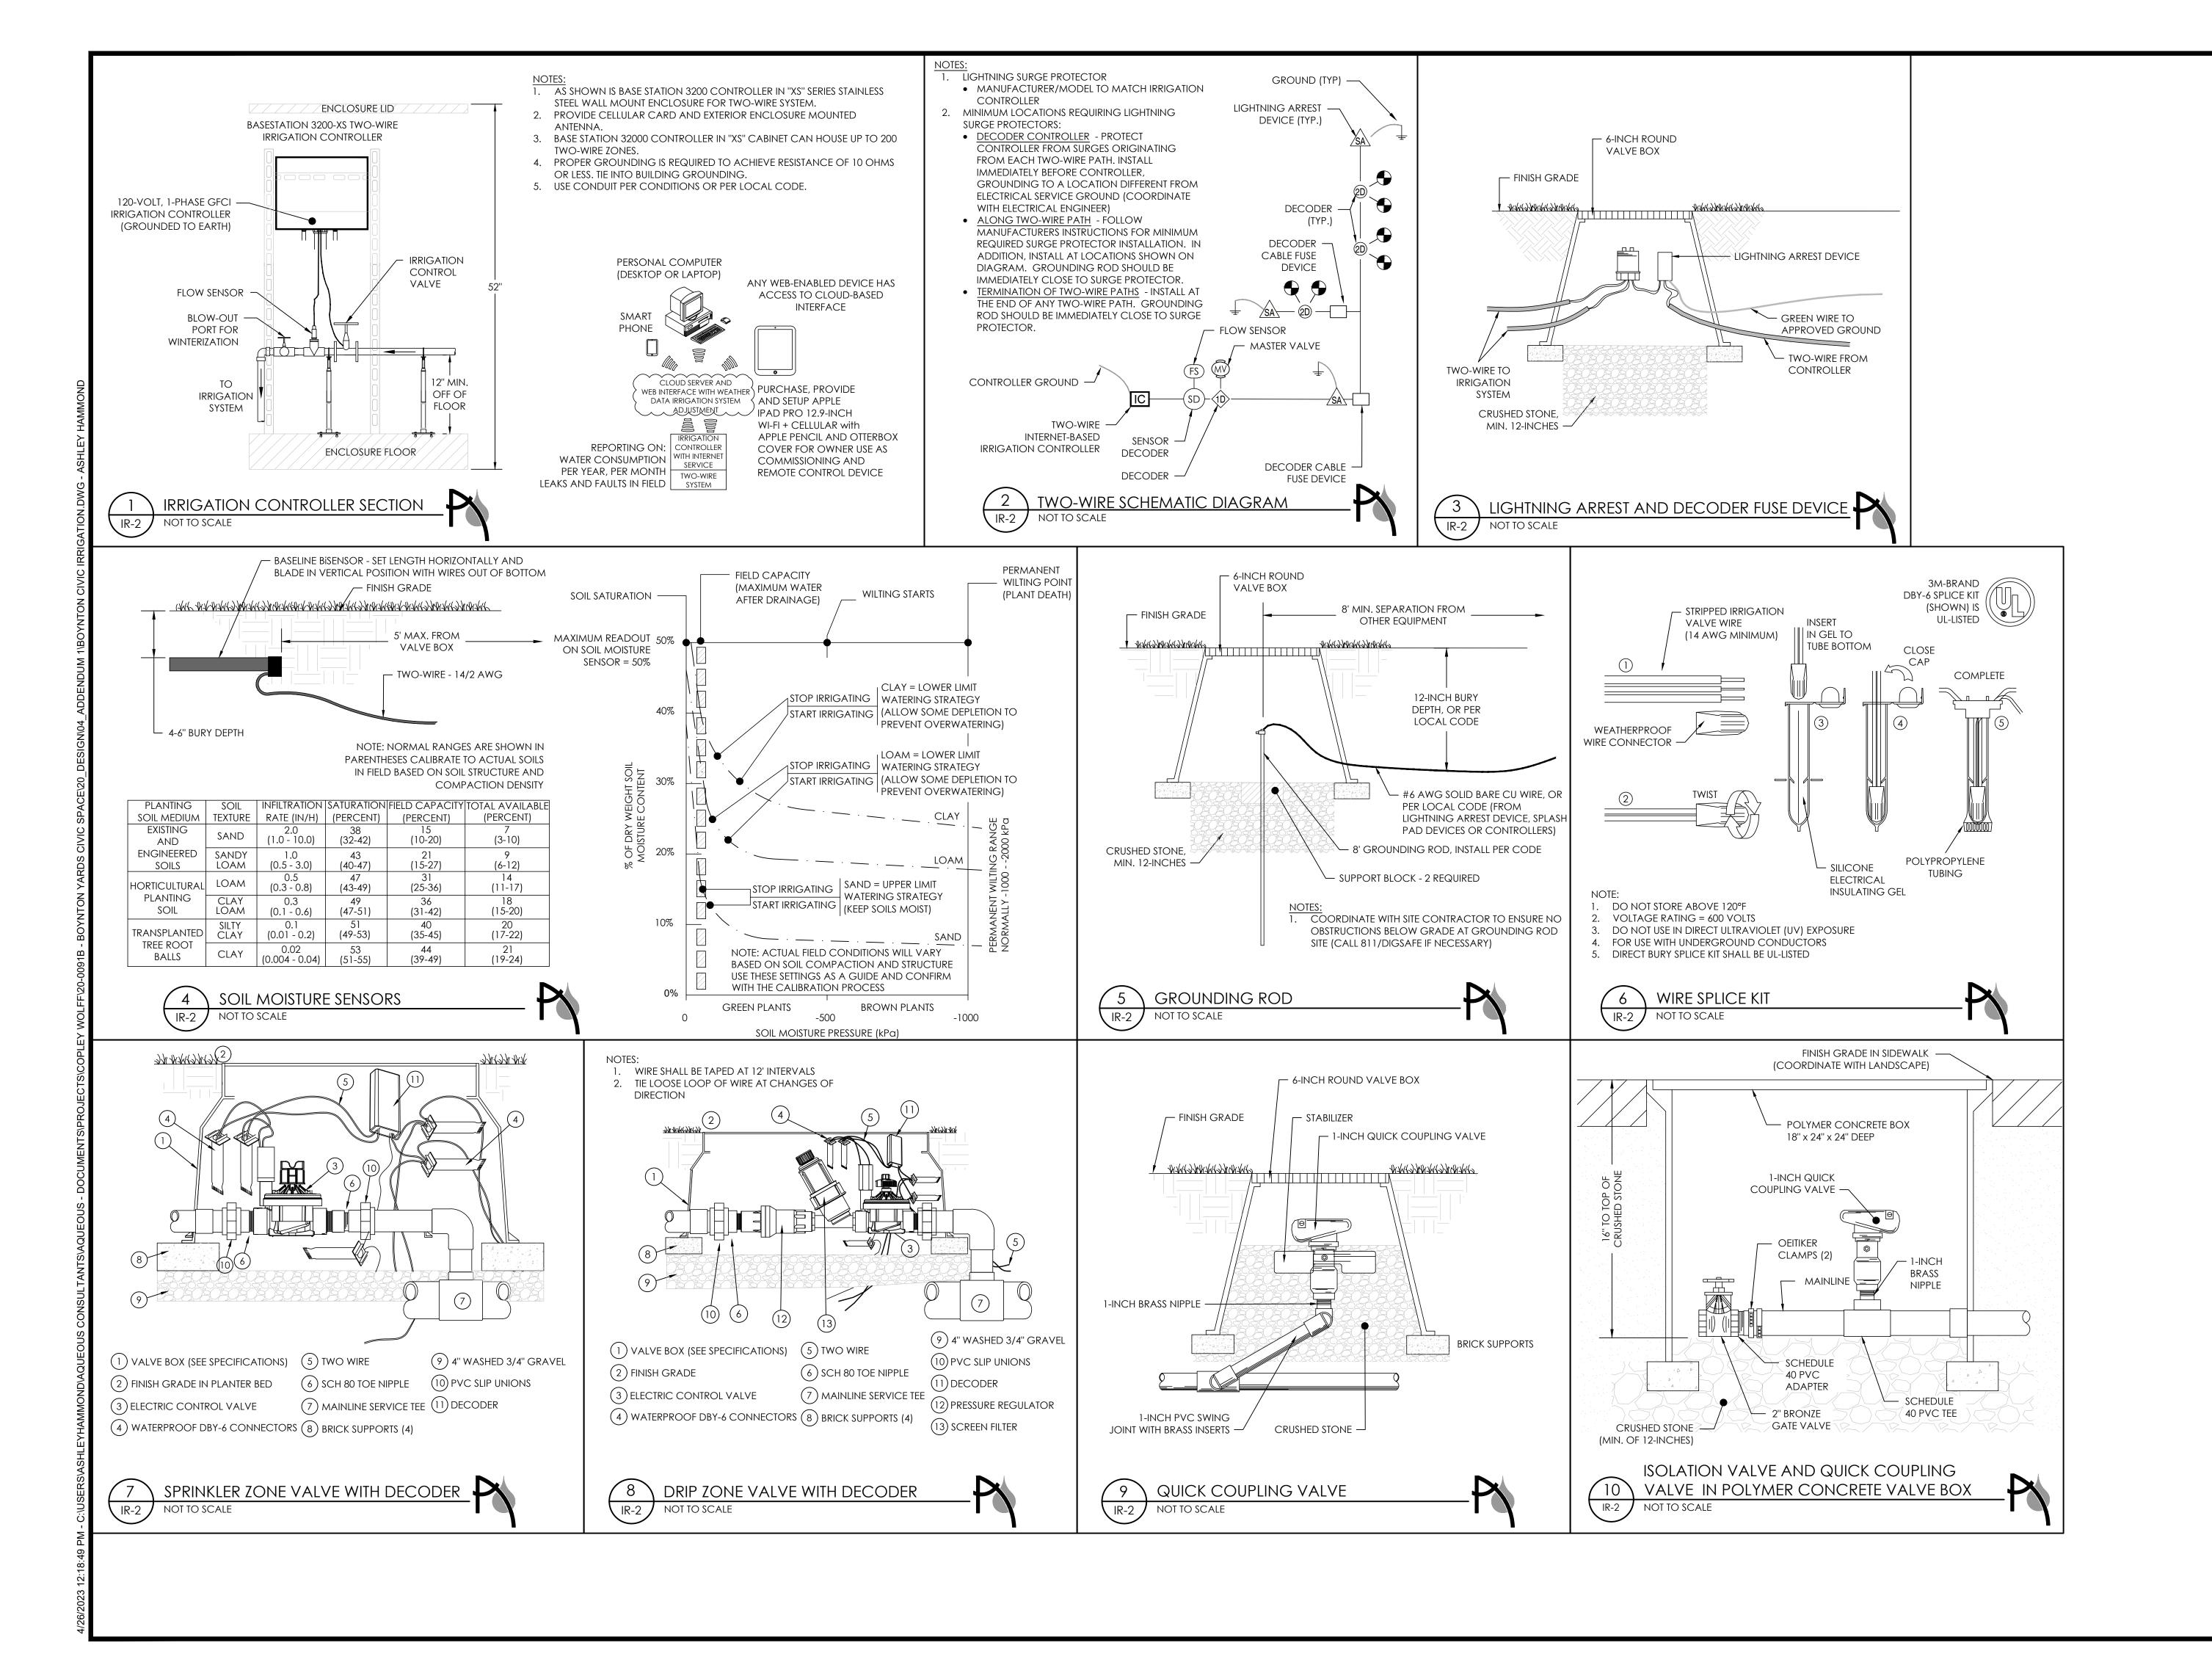

C W
D G

Copley Wolff Design Group
Landscape Architects & Planners

PROJECT NAME / CLIENT

ACE 1

NTON YARDS - CIVIC SPA 101 SOUTH STREET, SOMERVILLE, MA 101 SOUTH STREET OWNER LLC

CWDG PROJECT NUMBER: 2036.000
ISSUANCES:

REV # DATE DESCRIPTION

1 12.15.2020 BULLETIN 47
-INTERIM PARK

2 10.07.2022 90% CONSTRUCTION DOCUMENTS
3 3.10.2023 100% CONSTRUCTION DOCUMENTS
4 4.26.2023 ADDENDUM NO. 1



#### IRRIGATION DETAILS - 1

CHECKED BY: MI


SCALE:

3.10.23

SHEET 2 OF 10

DRAWING NUMBER:

IR-2

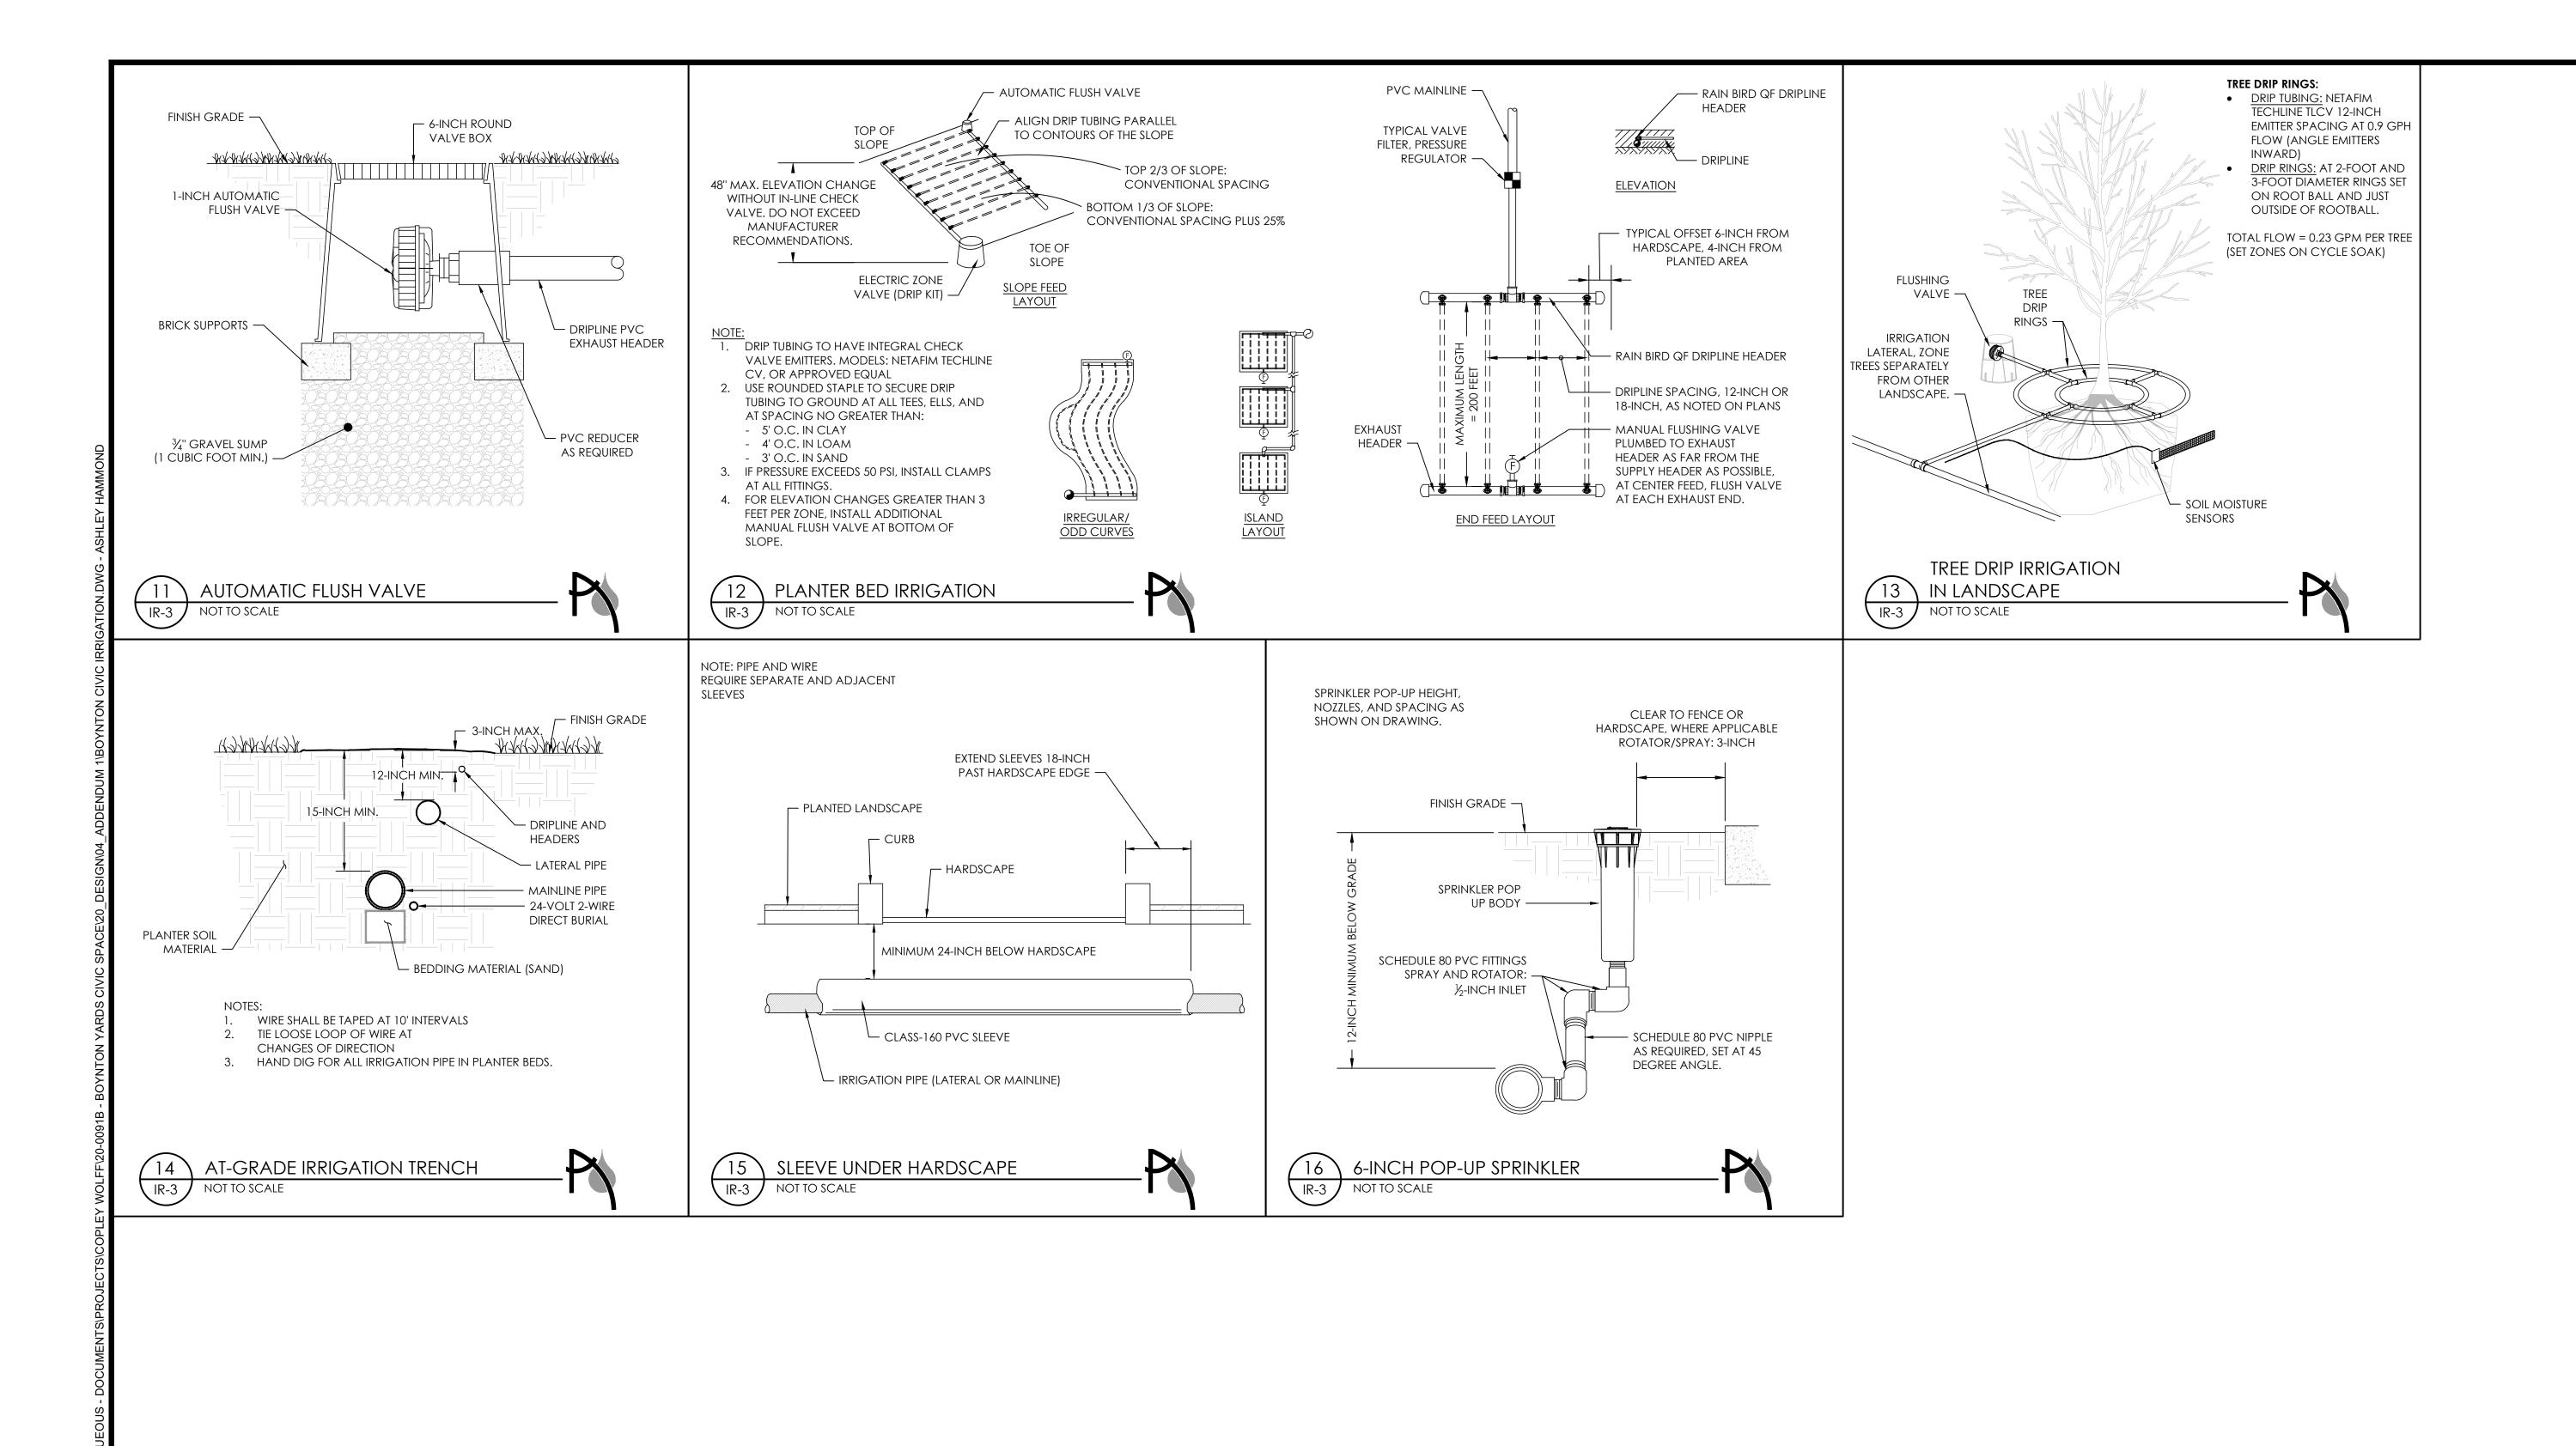

Copley Wolff Design Group Landscape Architects & Planners

PROJECT NAME / CLIENT:

S

CWDG PROJECT NUMBER: 2036 000

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REV # DATE DESCRIPTION 1 12.15.2020 BULLETIN 47 2 10.07.2022 90% CONSTRUCTION DOCUMENTS 3 3.10.2023 100% CONSTRUCTION DOCUMENTS 4 4.26.2023 ADDENDUM NO. 1



#### IRRIGATION DETAILS - 2

TSL CHECKED BY:

3.10.23

DRAWING NUMBER:

SHEET 3 OF 10

IR-3

- 5 FEET AND DEEPER REQUIRES PROTECTIVE SYSTEMS (SHORING, SLOPING, OR TRENCH BOX).
- 3. SAFE MEANS OF ACCESS/EGRESS EVERY 25 FEET WHEN
- 4. KEEP EXCAVATED MATERIALS (SPOILS) MORE THAN 2 FEET FROM EDGE OF EXCAVATION.
- 5. IDENTIFY LOCATION OF UTILITIES BY CALLING DigSafe
- 6. A TRENCH PERMIT MUST BE POSTED IN PLAIN VIEW ON THE
- 7. ALL REGULATED TRENCHES MUST BE EITHER ATTENDED, COVERED, BARRICADED, OR BACKFILLED.
- 8. EXCAVATORS WHO USE HOISTING EQUIPMENT MUST BE

- 2. OSHA-CERTIFIED PERSON REQUIRED TO PROVIDE INSPECTIONS TO TRENCH AND PROTECTIVE SYSTEM.
- TRENCH IS 4 FEET OR GREATER.
- 1-888-344-7233.
- SITE OF THE TRENCH.
- LICENSED BY MA DEPT OF PUBLIC SAFETY.



Copley Wolff Design Group Landscape Architects & Planners

PROJECT NAME / CLIENT:

01

CWDG PROJECT NUMBER: 2036.000

REV # DATE DESCRIPTION 1 12.15.2020 BULLETIN 47 -INTERIM PARK

2 10.07.2022 90% CONSTRUCTION DOCUMENTS 100% CONSTRUCTIO DOCUMENTS 3 3.10.2023

4 4.26.2023 ADDENDUM NO. 1 5 5.22.2023 ADDENDUM NO. 2





AQUEOUS CONSULTANTS, LLC 1 Dundee Park Drive, Suite 10

Andover, MA 01810 (978) 470-1695 www.aqueous.net

DESIGN BY:

Know what's below.

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PLAN


Scale 1" = 10'

DRAWING TITLE:
WATER FEATURE LAYOUT PLAN 1 OF 2


AEH

1" = 10' 3.10.23

SHEET 4 OF 10 RAWING NUMBER:

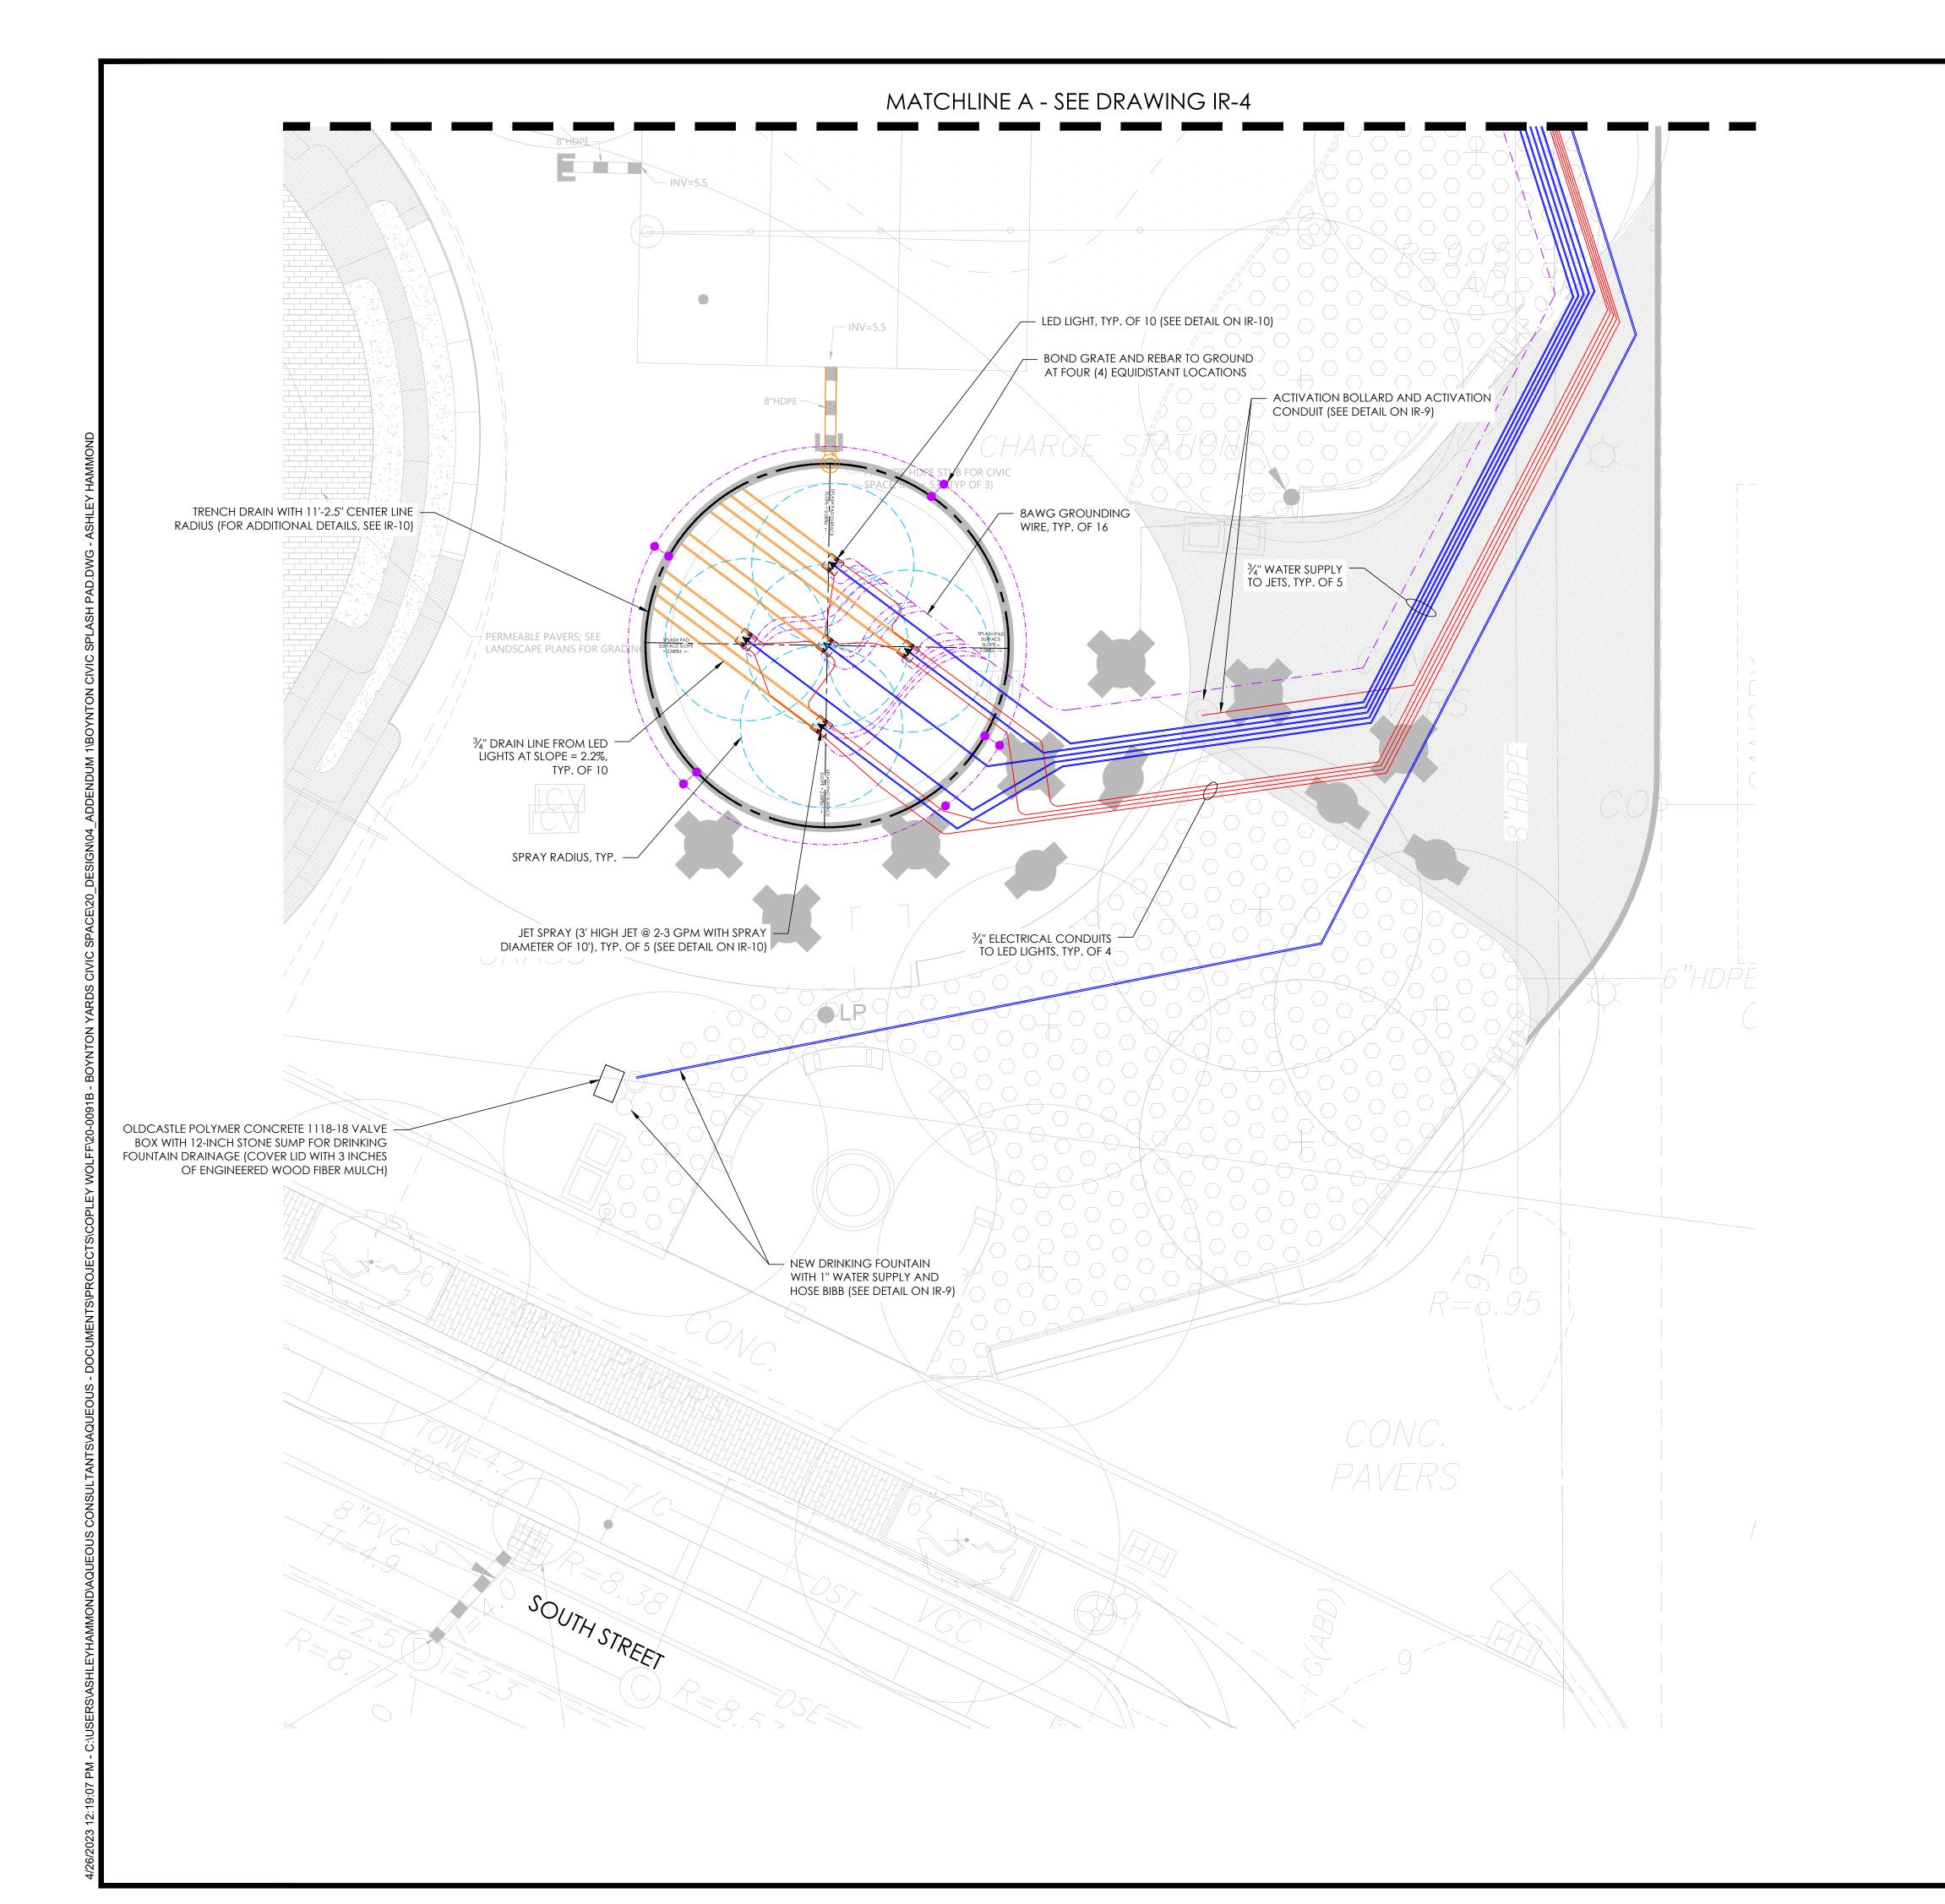

- (SHORING, SLOPING, OR TRENCH BOX).
- 3. SAFE MEANS OF ACCESS/EGRESS EVERY 25 FEET WHEN
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- 8. EXCAVATORS WHO USE HOISTING EQUIPMENT MUST BE

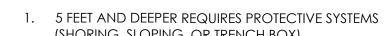



- TRENCH IS 4 FEET OR GREATER.

- SITE OF THE TRENCH.
- COVERED, BARRICADED, OR BACKFILLED.
- LICENSED BY MA DEPT OF PUBLIC SAFETY.



Copley Wolff Design Group Landscape Architects & Planners

PROJECT NAME / CLIENT:

0

CWDG PROJECT NUMBER: 2036.000

REV # DATE DESCRIPTION

1 12.15.2020 BULLETIN 47 -INTERIM PARK

2 10.07.2022 90% CONSTRUCTION DOCUMENTS

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PLAN


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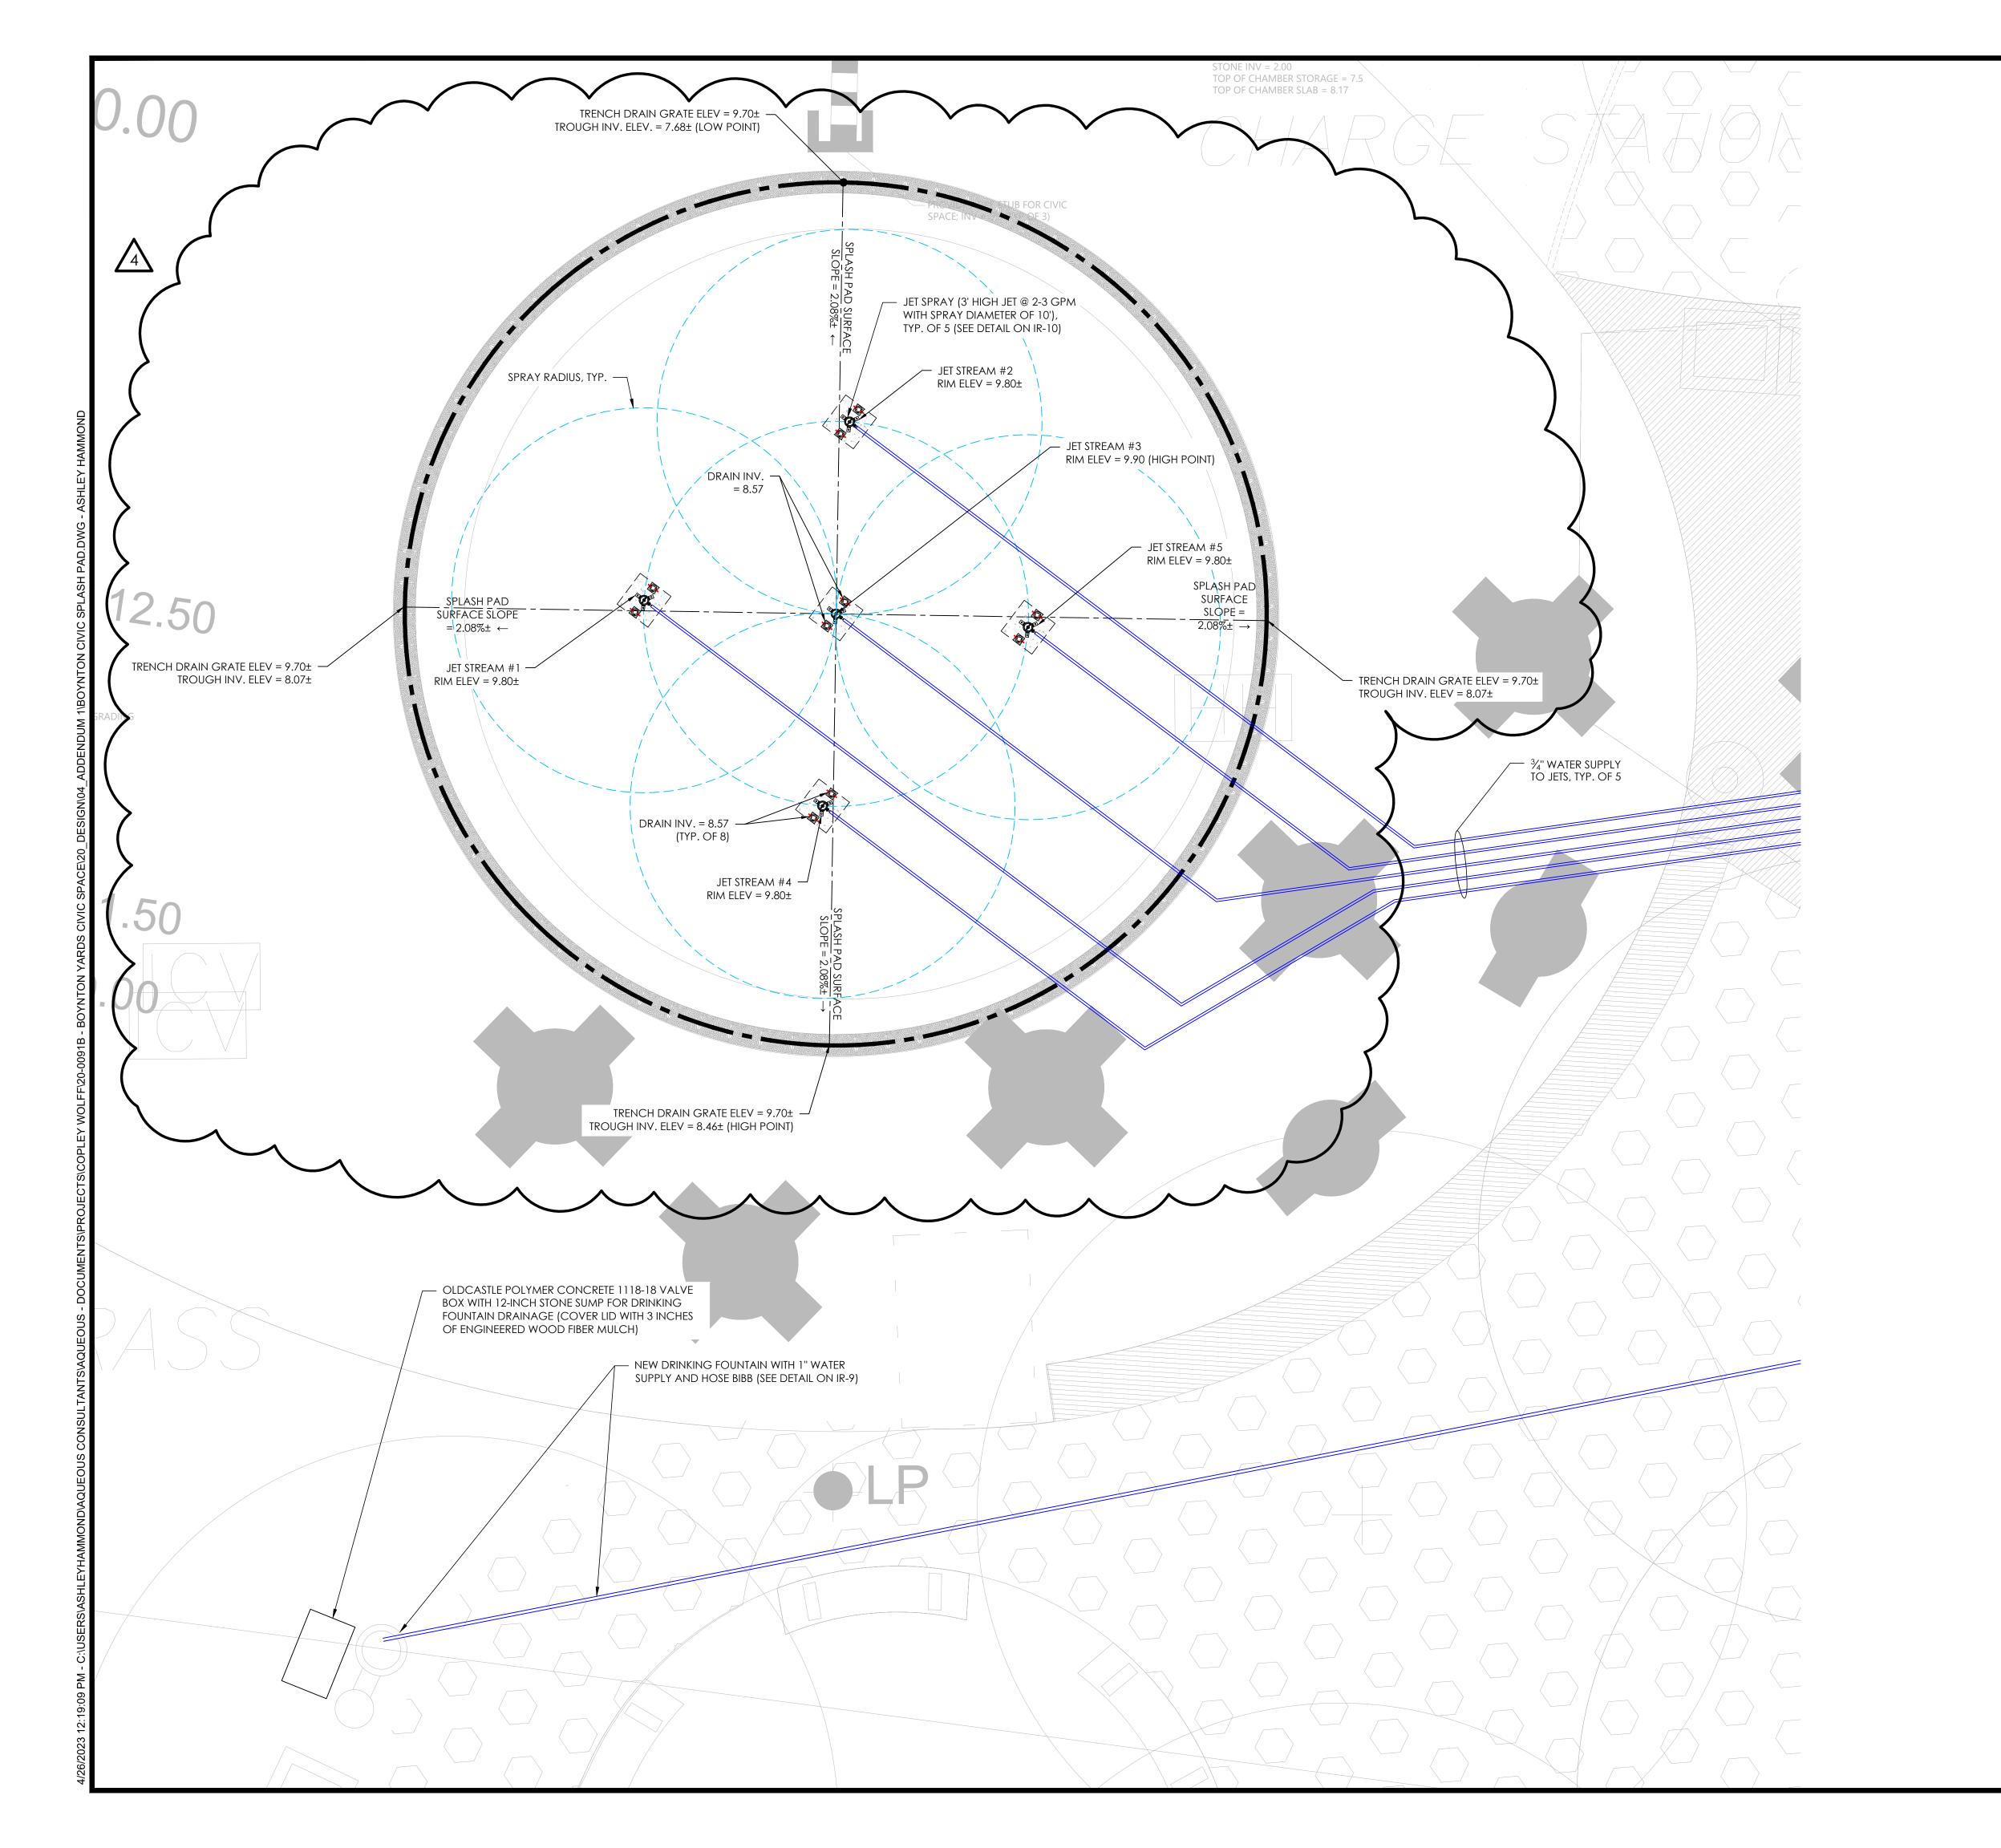
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WATER FEATURE 1 Dundee Park Drive, Suite 10 LAYOUT PLAN Andover, MA 01810 2 OF 2

AEH

1" = 5' 3.10.23


SHEET 6 OF 10 DRAWING NUMBER:



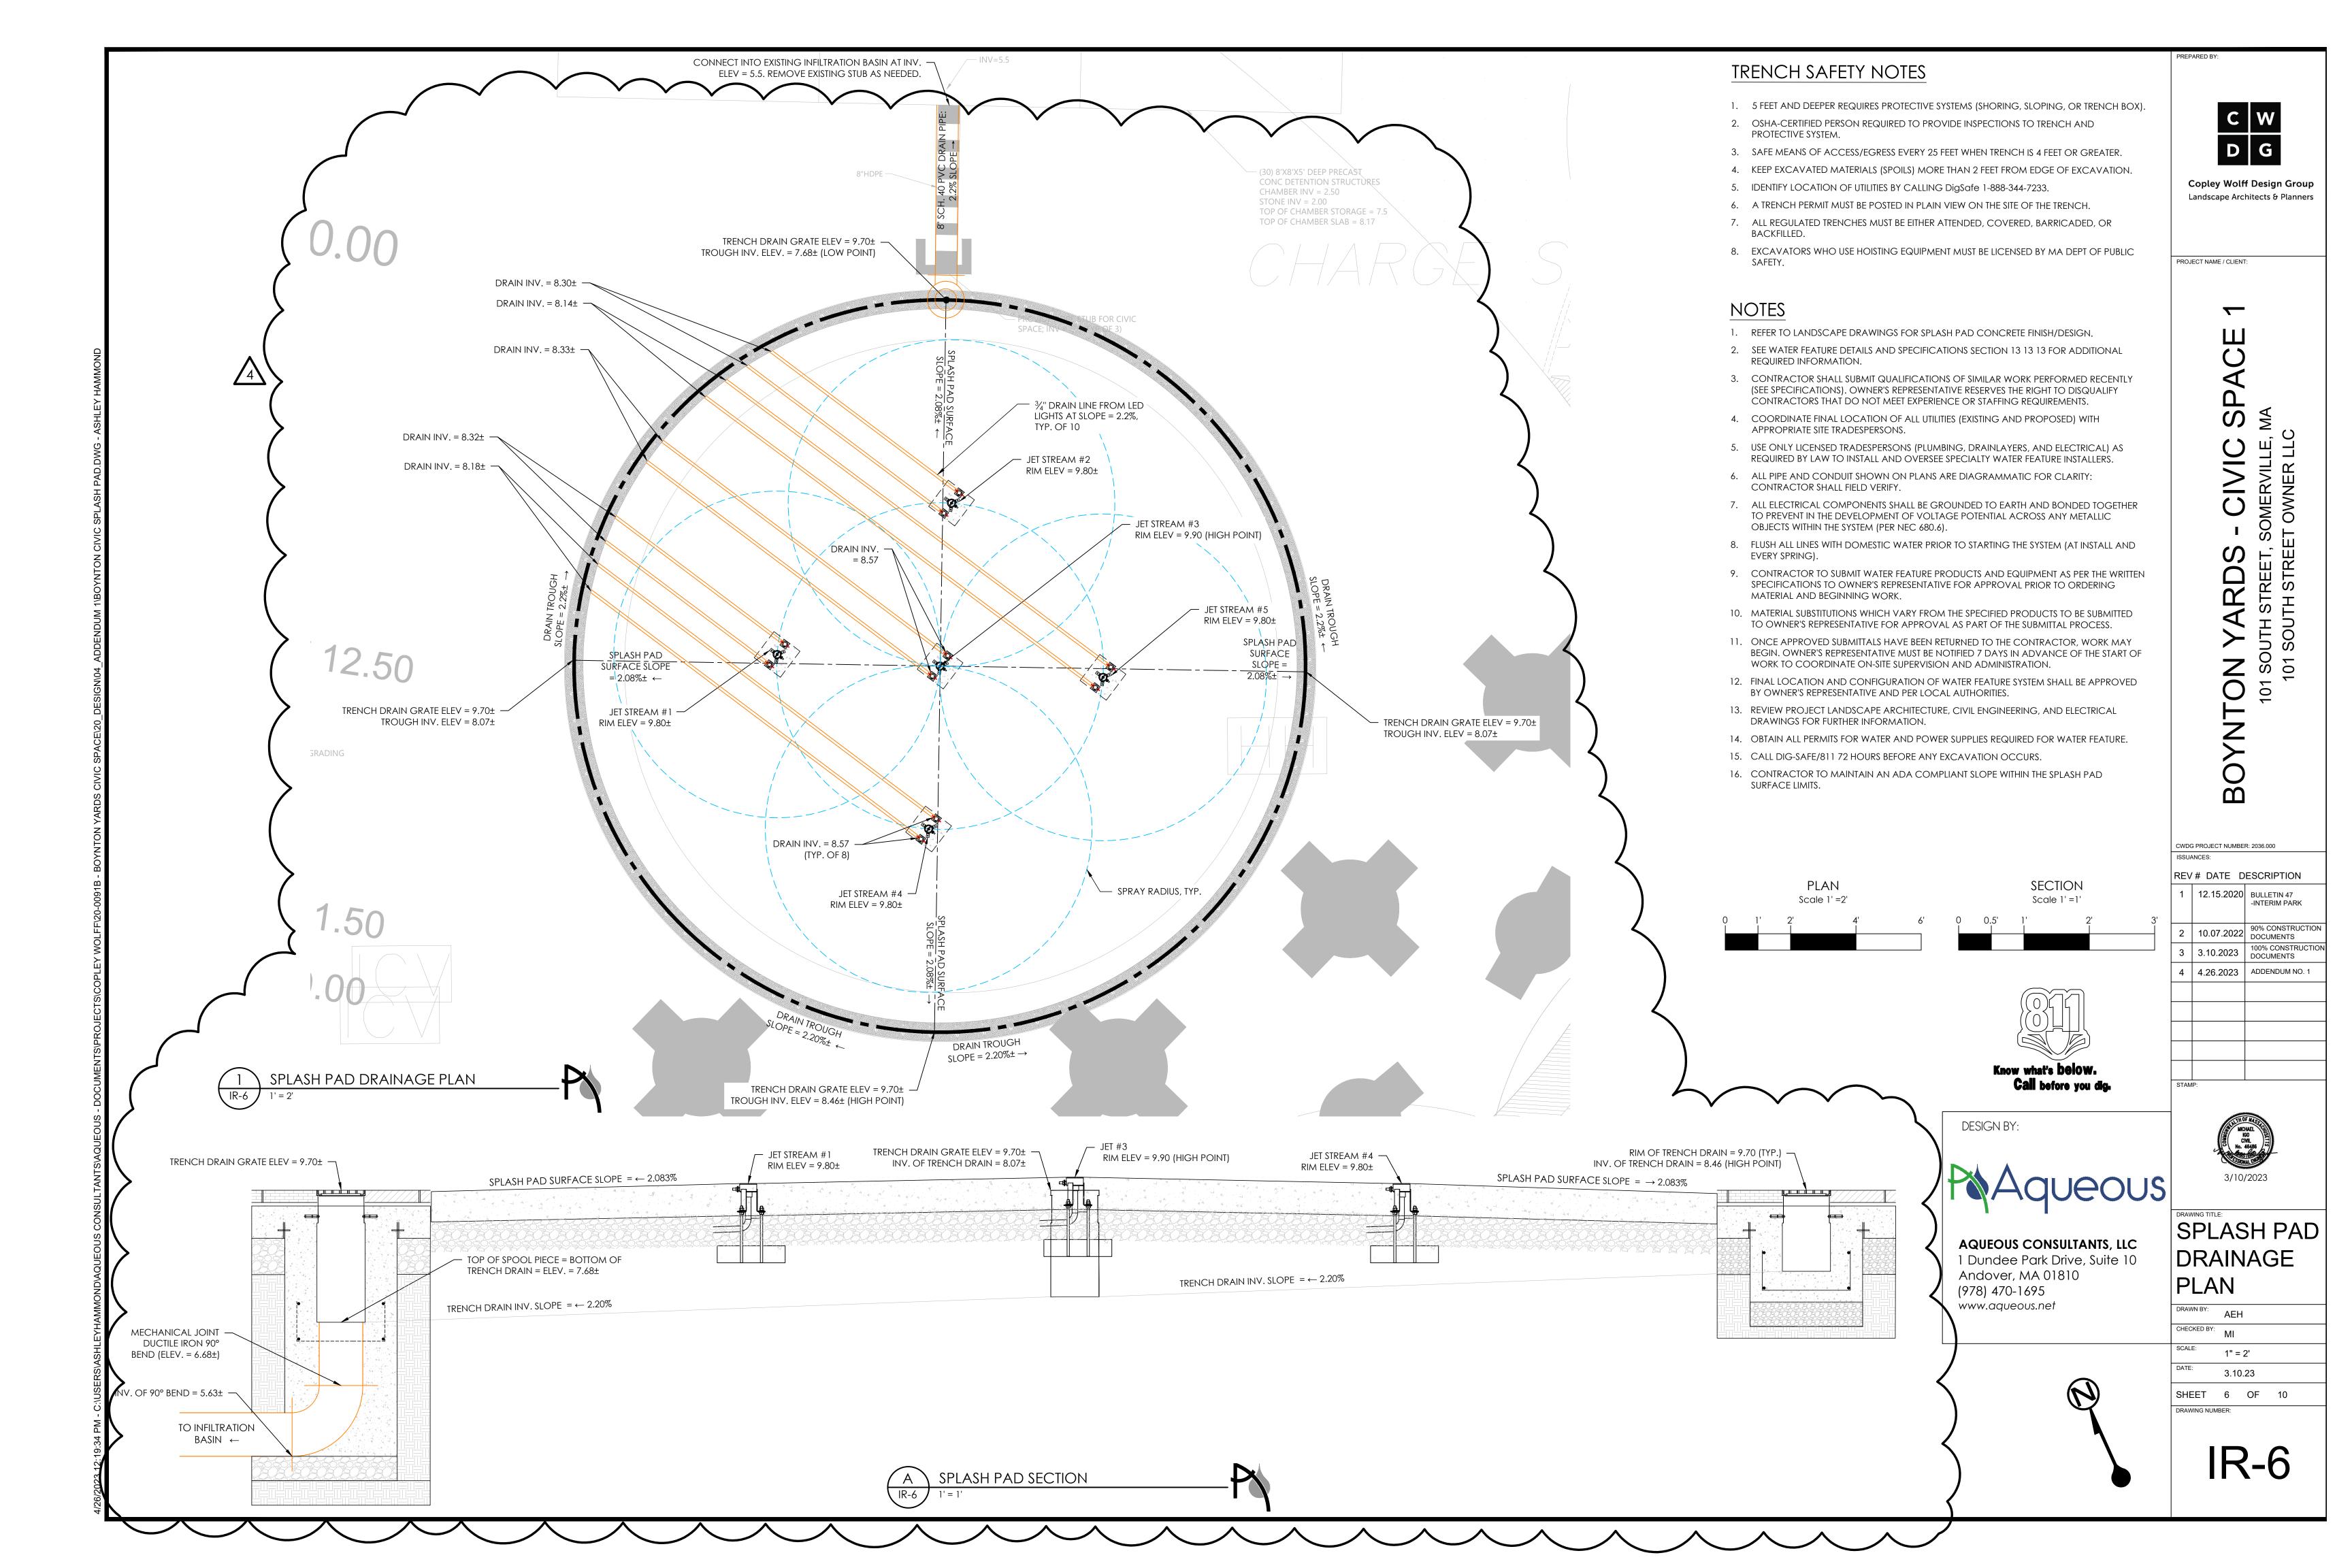

- 1. 5 FEET AND DEEPER REQUIRES PROTECTIVE SYSTEMS (SHORING, SLOPING, OR
- 2. OSHA-CERTIFIED PERSON REQUIRED TO PROVIDE INSPECTIONS TO TRENCH AND
- 3. SAFE MEANS OF ACCESS/EGRESS EVERY 25 FEET WHEN TRENCH IS 4 FEET OR
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- 8. EXCAVATORS WHO USE HOISTING EQUIPMENT MUST BE LICENSED BY MA DEPT OF PUBLIC SAFETY.

- 1. REFER TO LANDSCAPE DRAWINGS FOR SPLASH PAD CONCRETE FINISH/DESIGN.
- 2. SEE WATER FEATURE DETAILS AND SPECIFICATIONS SECTION 13 13 13 FOR ADDITIONAL REQUIRED INFORMATION.
- 3. CONTRACTOR SHALL SUBMIT QUALIFICATIONS OF SIMILAR WORK PERFORMED RECENTLY (SEE SPECIFICATIONS). OWNER'S REPRESENTATIVE RESERVES THE RIGHT TO DISQUALIFY CONTRACTORS THAT DO NOT MEET EXPERIENCE OR STAFFING
- 4. COORDINATE FINAL LOCATION OF ALL UTILITIES (EXISTING AND PROPOSED) WITH APPROPRIATE SITE TRADESPERSONS.
- 5. USE ONLY LICENSED TRADESPERSONS (PLUMBING, DRAINLAYERS, AND ELECTRICAL) AS REQUIRED BY LAW TO INSTALL AND OVERSEE SPECIALTY WATER FEATURE
- 6. ALL PIPE AND CONDUIT SHOWN ON PLANS ARE DIAGRAMMATIC FOR CLARITY: CONTRACTOR SHALL FIELD VERIFY.
- 7. ALL ELECTRICAL COMPONENTS SHALL BE GROUNDED TO EARTH AND BONDED TOGETHER TO PREVENT IN THE DEVELOPMENT OF VOLTAGE POTENTIAL ACROSS ANY METALLIC OBJECTS WITHIN THE SYSTEM (PER NEC 680.6).
- 8. FLUSH ALL LINES WITH DOMESTIC WATER PRIOR TO STARTING THE SYSTEM (AT INSTALL AND EVERY SPRING).
- 9. CONTRACTOR TO SUBMIT WATER FEATURE PRODUCTS AND EQUIPMENT AS PER THE WRITTEN SPECIFICATIONS TO OWNER'S REPRESENTATIVE FOR APPROVAL PRIOR TO ORDERING MATERIAL AND BEGINNING WORK.
- 10. MATERIAL SUBSTITUTIONS WHICH VARY FROM THE SPECIFIED PRODUCTS TO BE SUBMITTED TO OWNER'S REPRESENTATIVE FOR APPROVAL AS PART OF THE SUBMITTAL
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- 12. FINAL LOCATION AND CONFIGURATION OF WATER FEATURE SYSTEM SHALL BE APPROVED BY OWNER'S REPRESENTATIVE AND PER LOCAL AUTHORITIES.
- 13. REVIEW PROJECT LANDSCAPE ARCHITECTURE, CIVIL ENGINEERING, AND ELECTRICAL DRAWINGS FOR FURTHER INFORMATION.
- 14. OBTAIN ALL PERMITS FOR WATER AND POWER SUPPLIES REQUIRED FOR WATER
- 15. CALL DIG-SAFE/811 72 HOURS BEFORE ANY EXCAVATION OCCURS.
- 16. CONTRACTOR TO MAINTAIN AN ADA COMPLIANT SLOPE WITHIN THE SPLASH PAD SURFACE LIMITS.

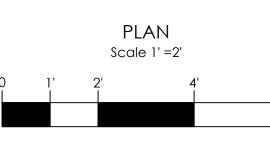




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WDG PROJECT NUMBER: 2036.000

3.10.2023

4 4.26.2023

REV # DATE DESCRIPTION

12.15.2020 BULLETIN 47 -INTERIM PARK

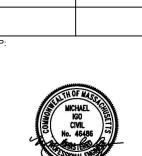10.07.2022 90% CONSTRUCTION DOCUMENTS

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ADDENDUM NO. 1

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Landscape Architects & Planners


PROJECT NAME / CLIENT:

SPLASH PAD WATER PLAN


AEH 1" = 2' 3.10.23

SHEET 7 OF 10

RAWING NUMBER:

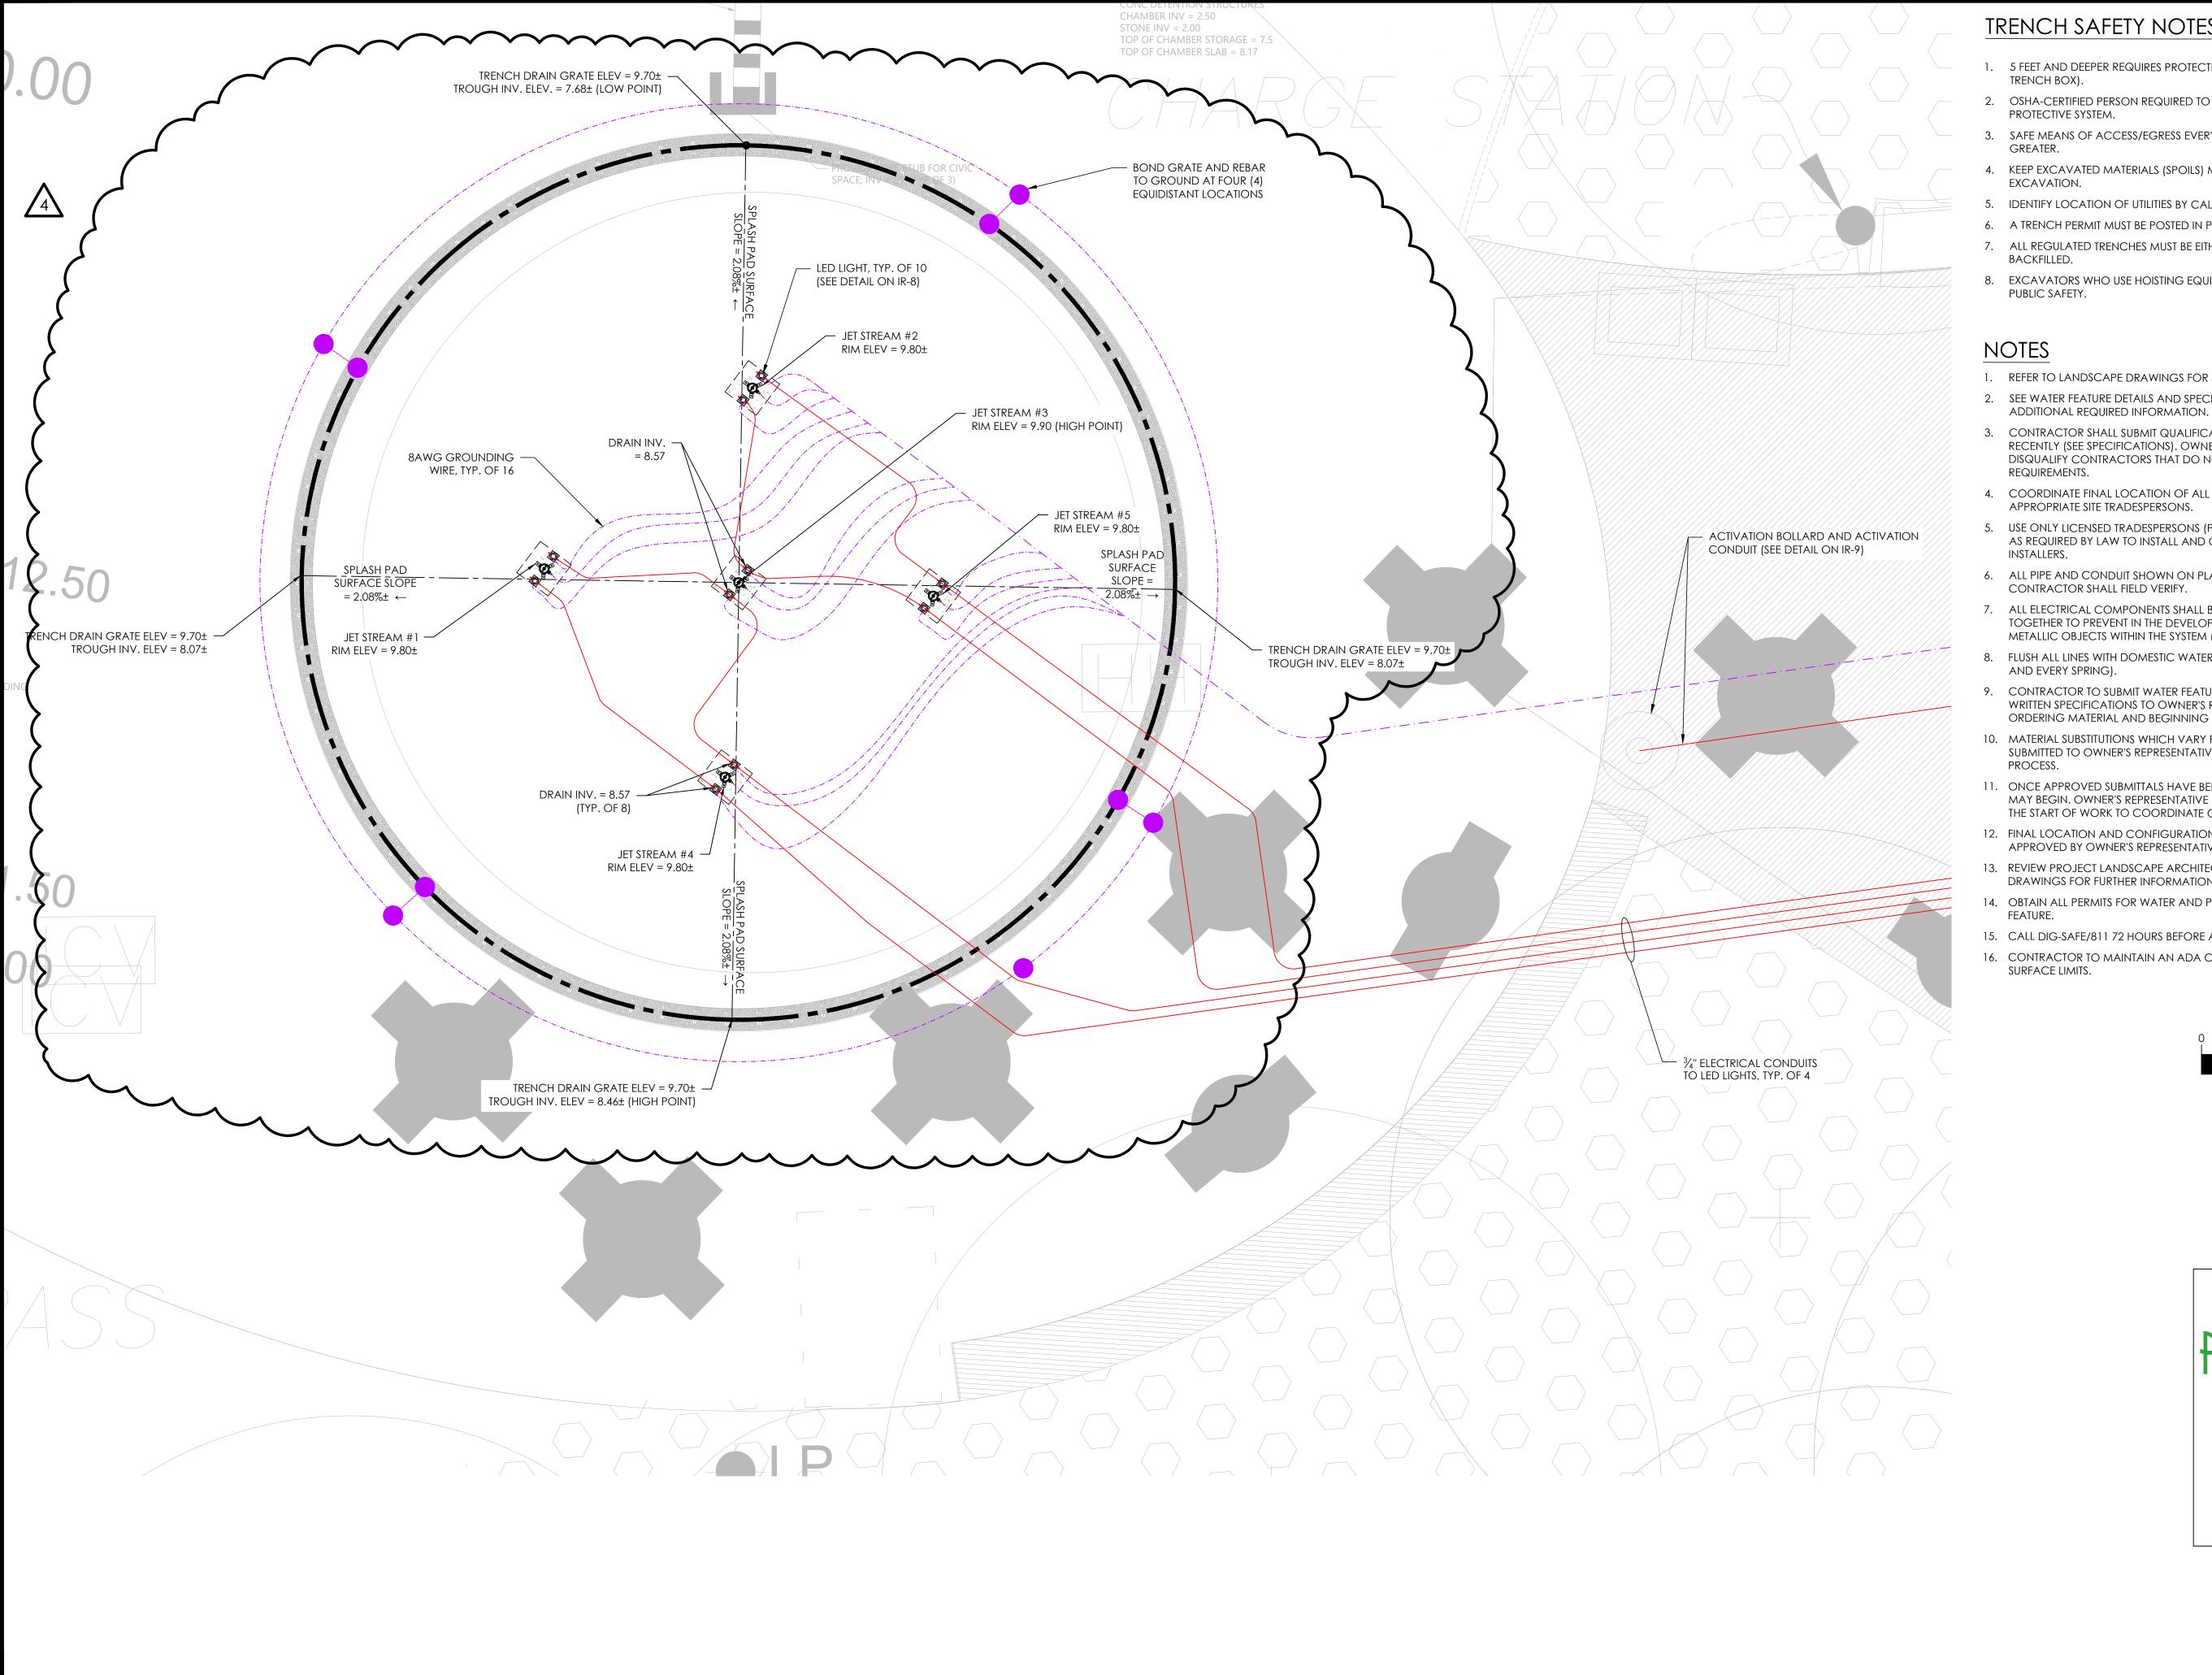

- 1. 5 FEET AND DEEPER REQUIRES PROTECTIVE SYSTEMS (SHORING, SLOPING, OR
- 2. OSHA-CERTIFIED PERSON REQUIRED TO PROVIDE INSPECTIONS TO TRENCH AND
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- 1. REFER TO LANDSCAPE DRAWINGS FOR SPLASH PAD CONCRETE FINISH/DESIGN.
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SHEET 8 OF 10 RAWING NUMBER:

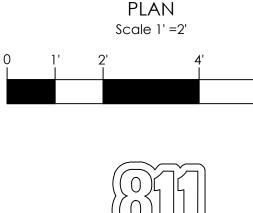

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PROJECT NAME / CLIENT:


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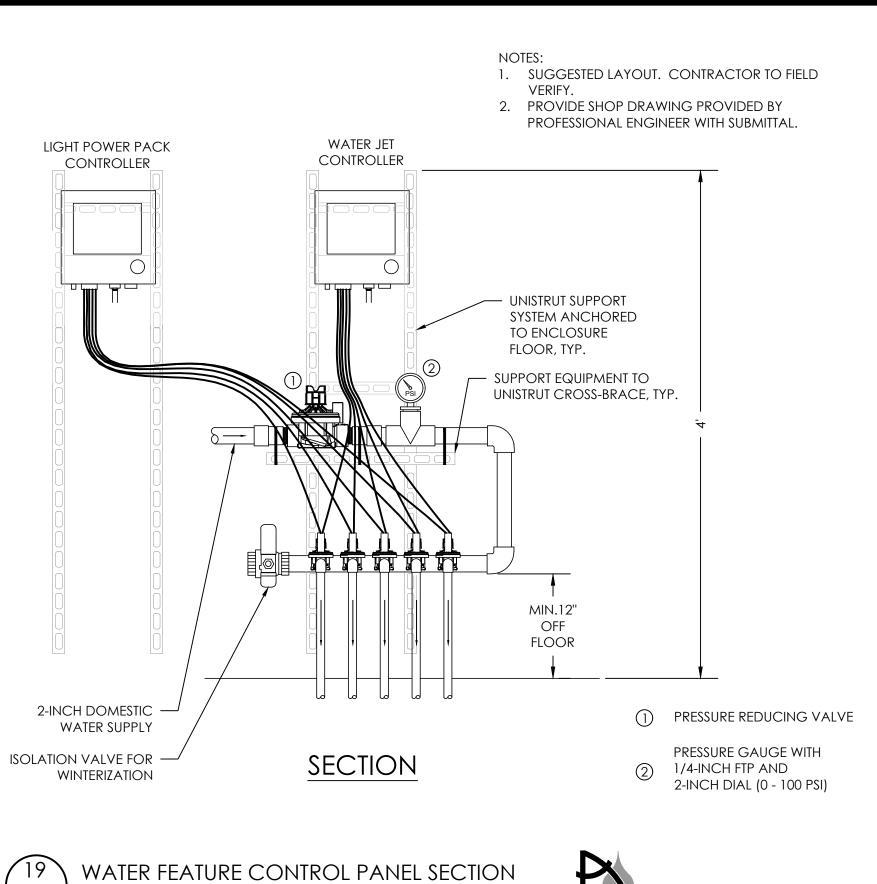
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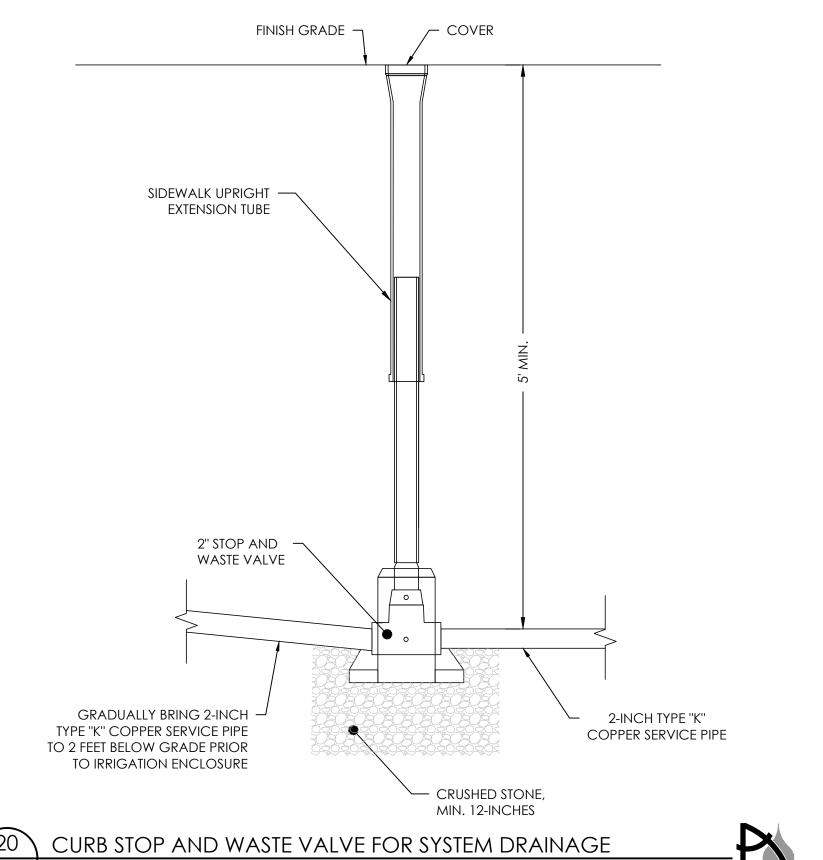
1 12.15.2020 BULLETIN 47
-INTERIM PARK 10.07.2022 90% CONSTRUCTION DOCUMENTS


100% CONSTRUCTIO DOCUMENTS 3.10.2023 4 4.26.2023 ADDENDUM NO. 1


SPLASH PAD ELECTRICAL





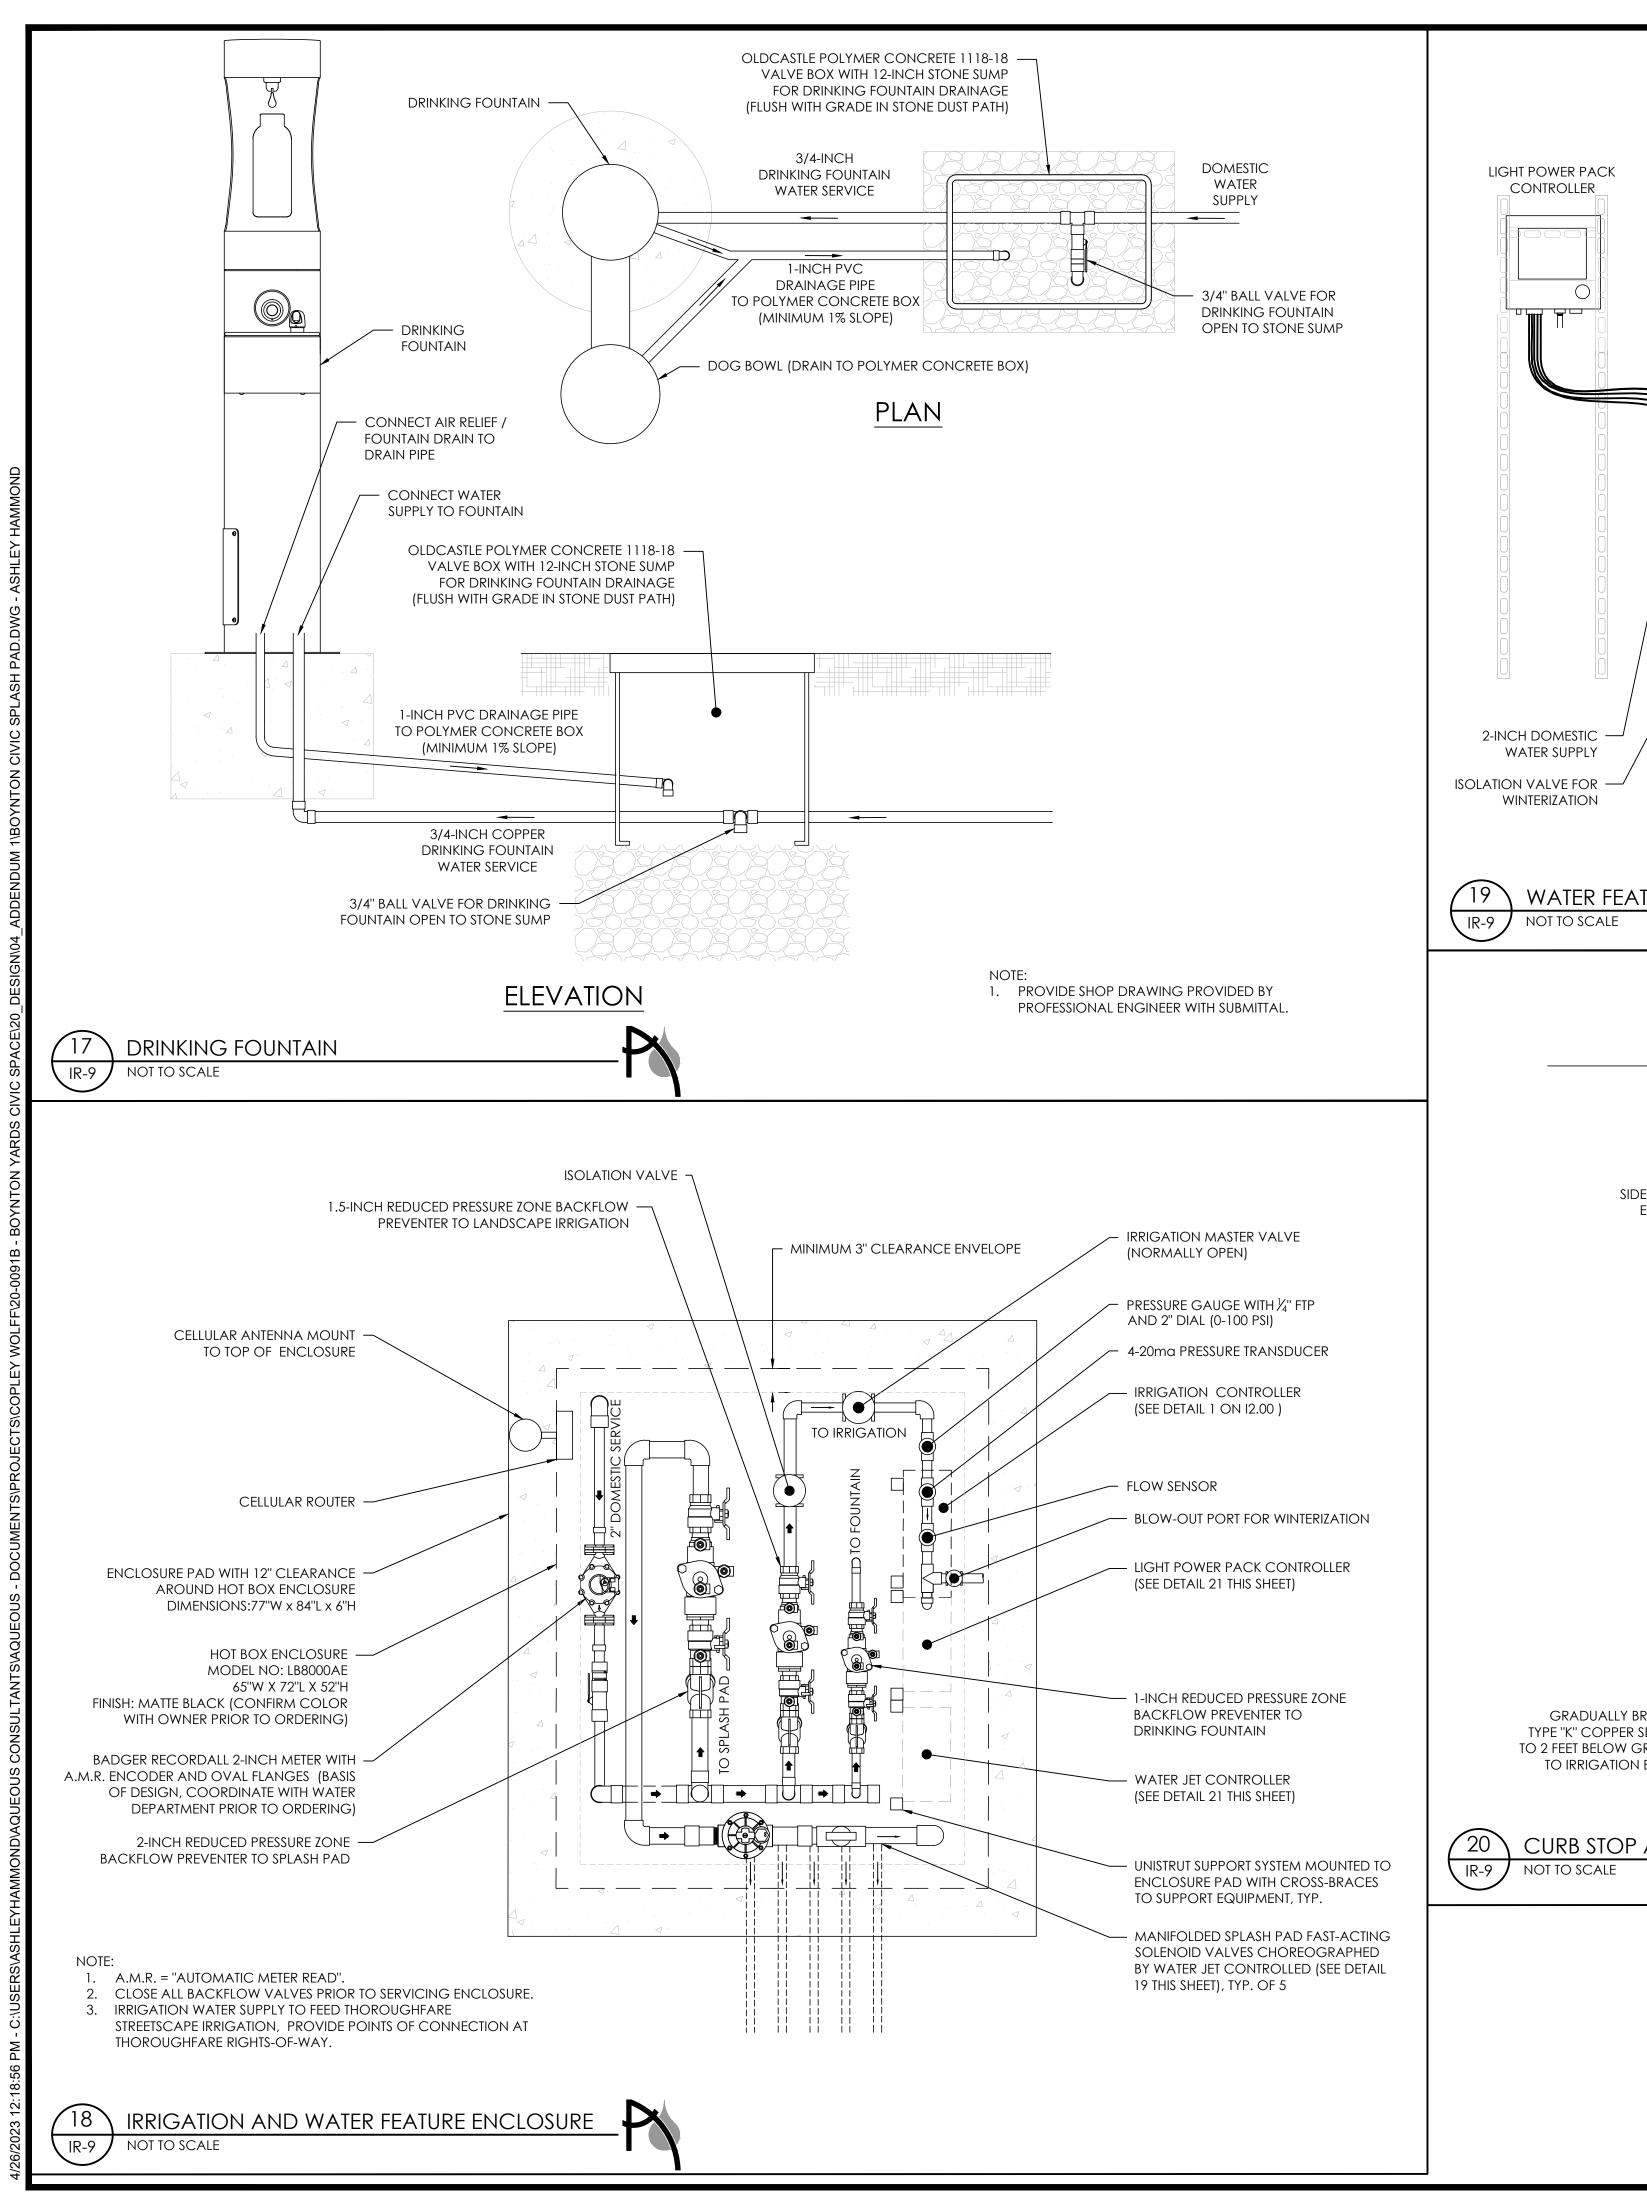

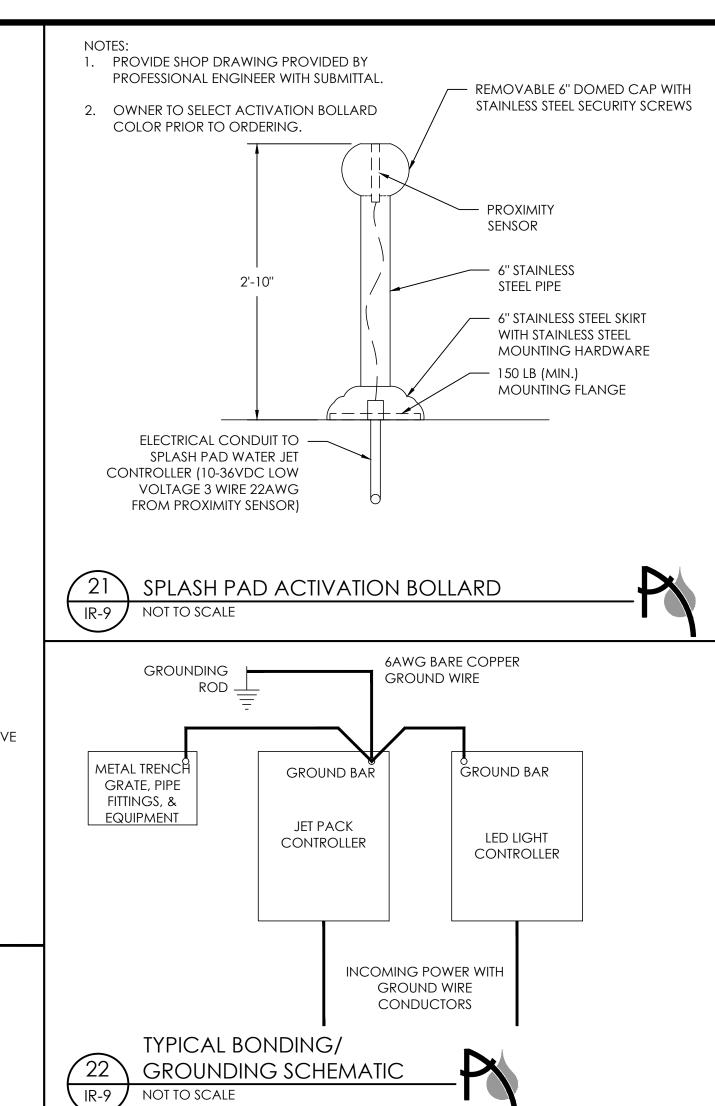

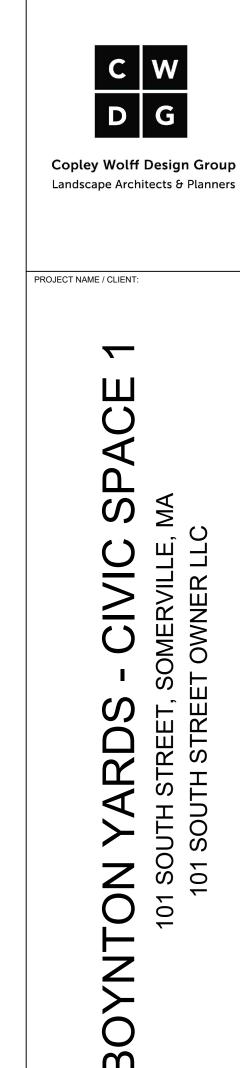

CWDG PROJECT NUMBER: 2036.000

ISSUANCES:

REV # DATE DESCRIPTION

1 12.15.2020 BULLETIN 47
-INTERIM PARK

2 10.07.2022 90% CONSTRUCTION DOCUMENTS

3 3.10.2023 100% CONSTRUCTION DOCUMENTS

4 4.26.2023 ADDENDUM NO. 1

STAMP:



WATER
FEATURE
DETAILS - 1

CHECKED BY: MI


SCALE: AS SHOWN

DATE: 3.10.23

SHEET 9 OF 10

DRAWING NUMBER:

IR-9

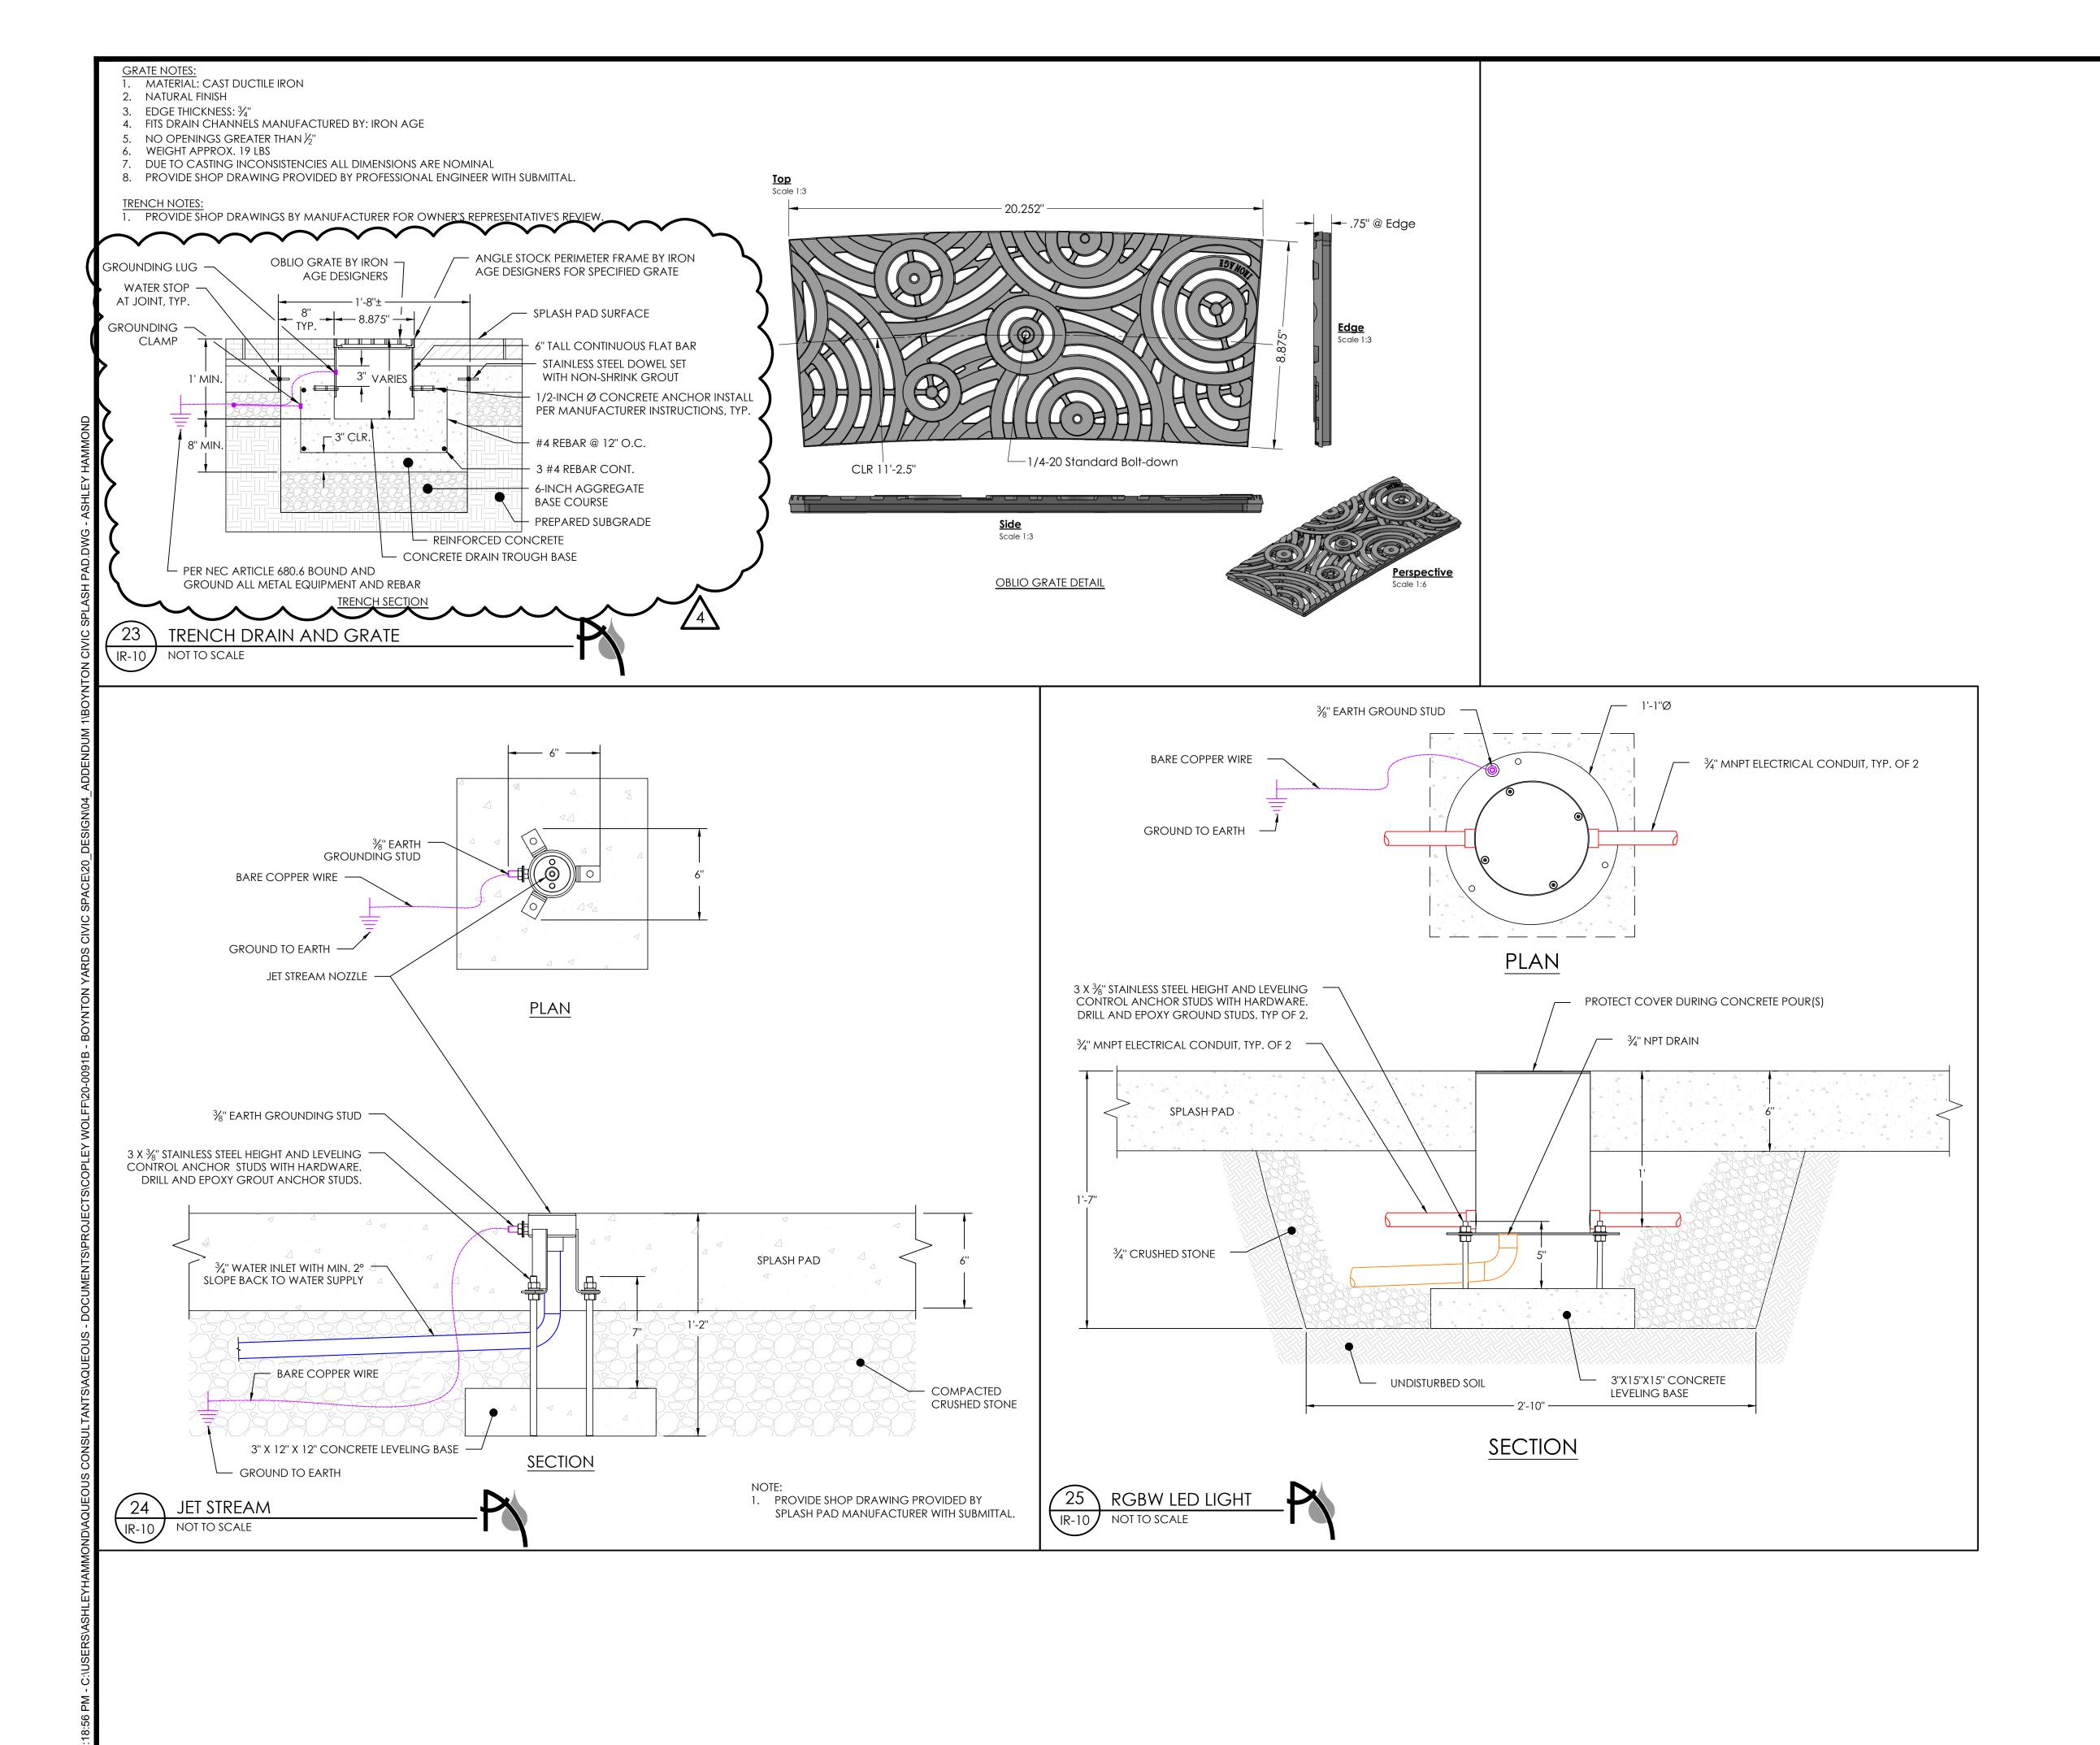

C W
D G

Copley Wolff Design Group
Landscape Architects & Planners

PROJECT NAME / CLIENT:

## RDS - CIVIC SPACE

CWDG PROJECT NUMBER: 2036.000
ISSUANCES:

REV # DATE DESCRIPTION

1 12.15.2020 BULLETIN 47
-INTERIM PARK

01

 2
 10.07.2022
 90% CONSTRUCTION DOCUMENTS

 3
 3.10.2023
 100% CONSTRUCTION DOCUMENTS

 4
 4.26.2023
 ADDENDUM NO. 1



WATER
FEATURE
DETAILS - 2

DRAWN BY: AEH

CHECKED BY: MI

SCALE: AS SHOW!


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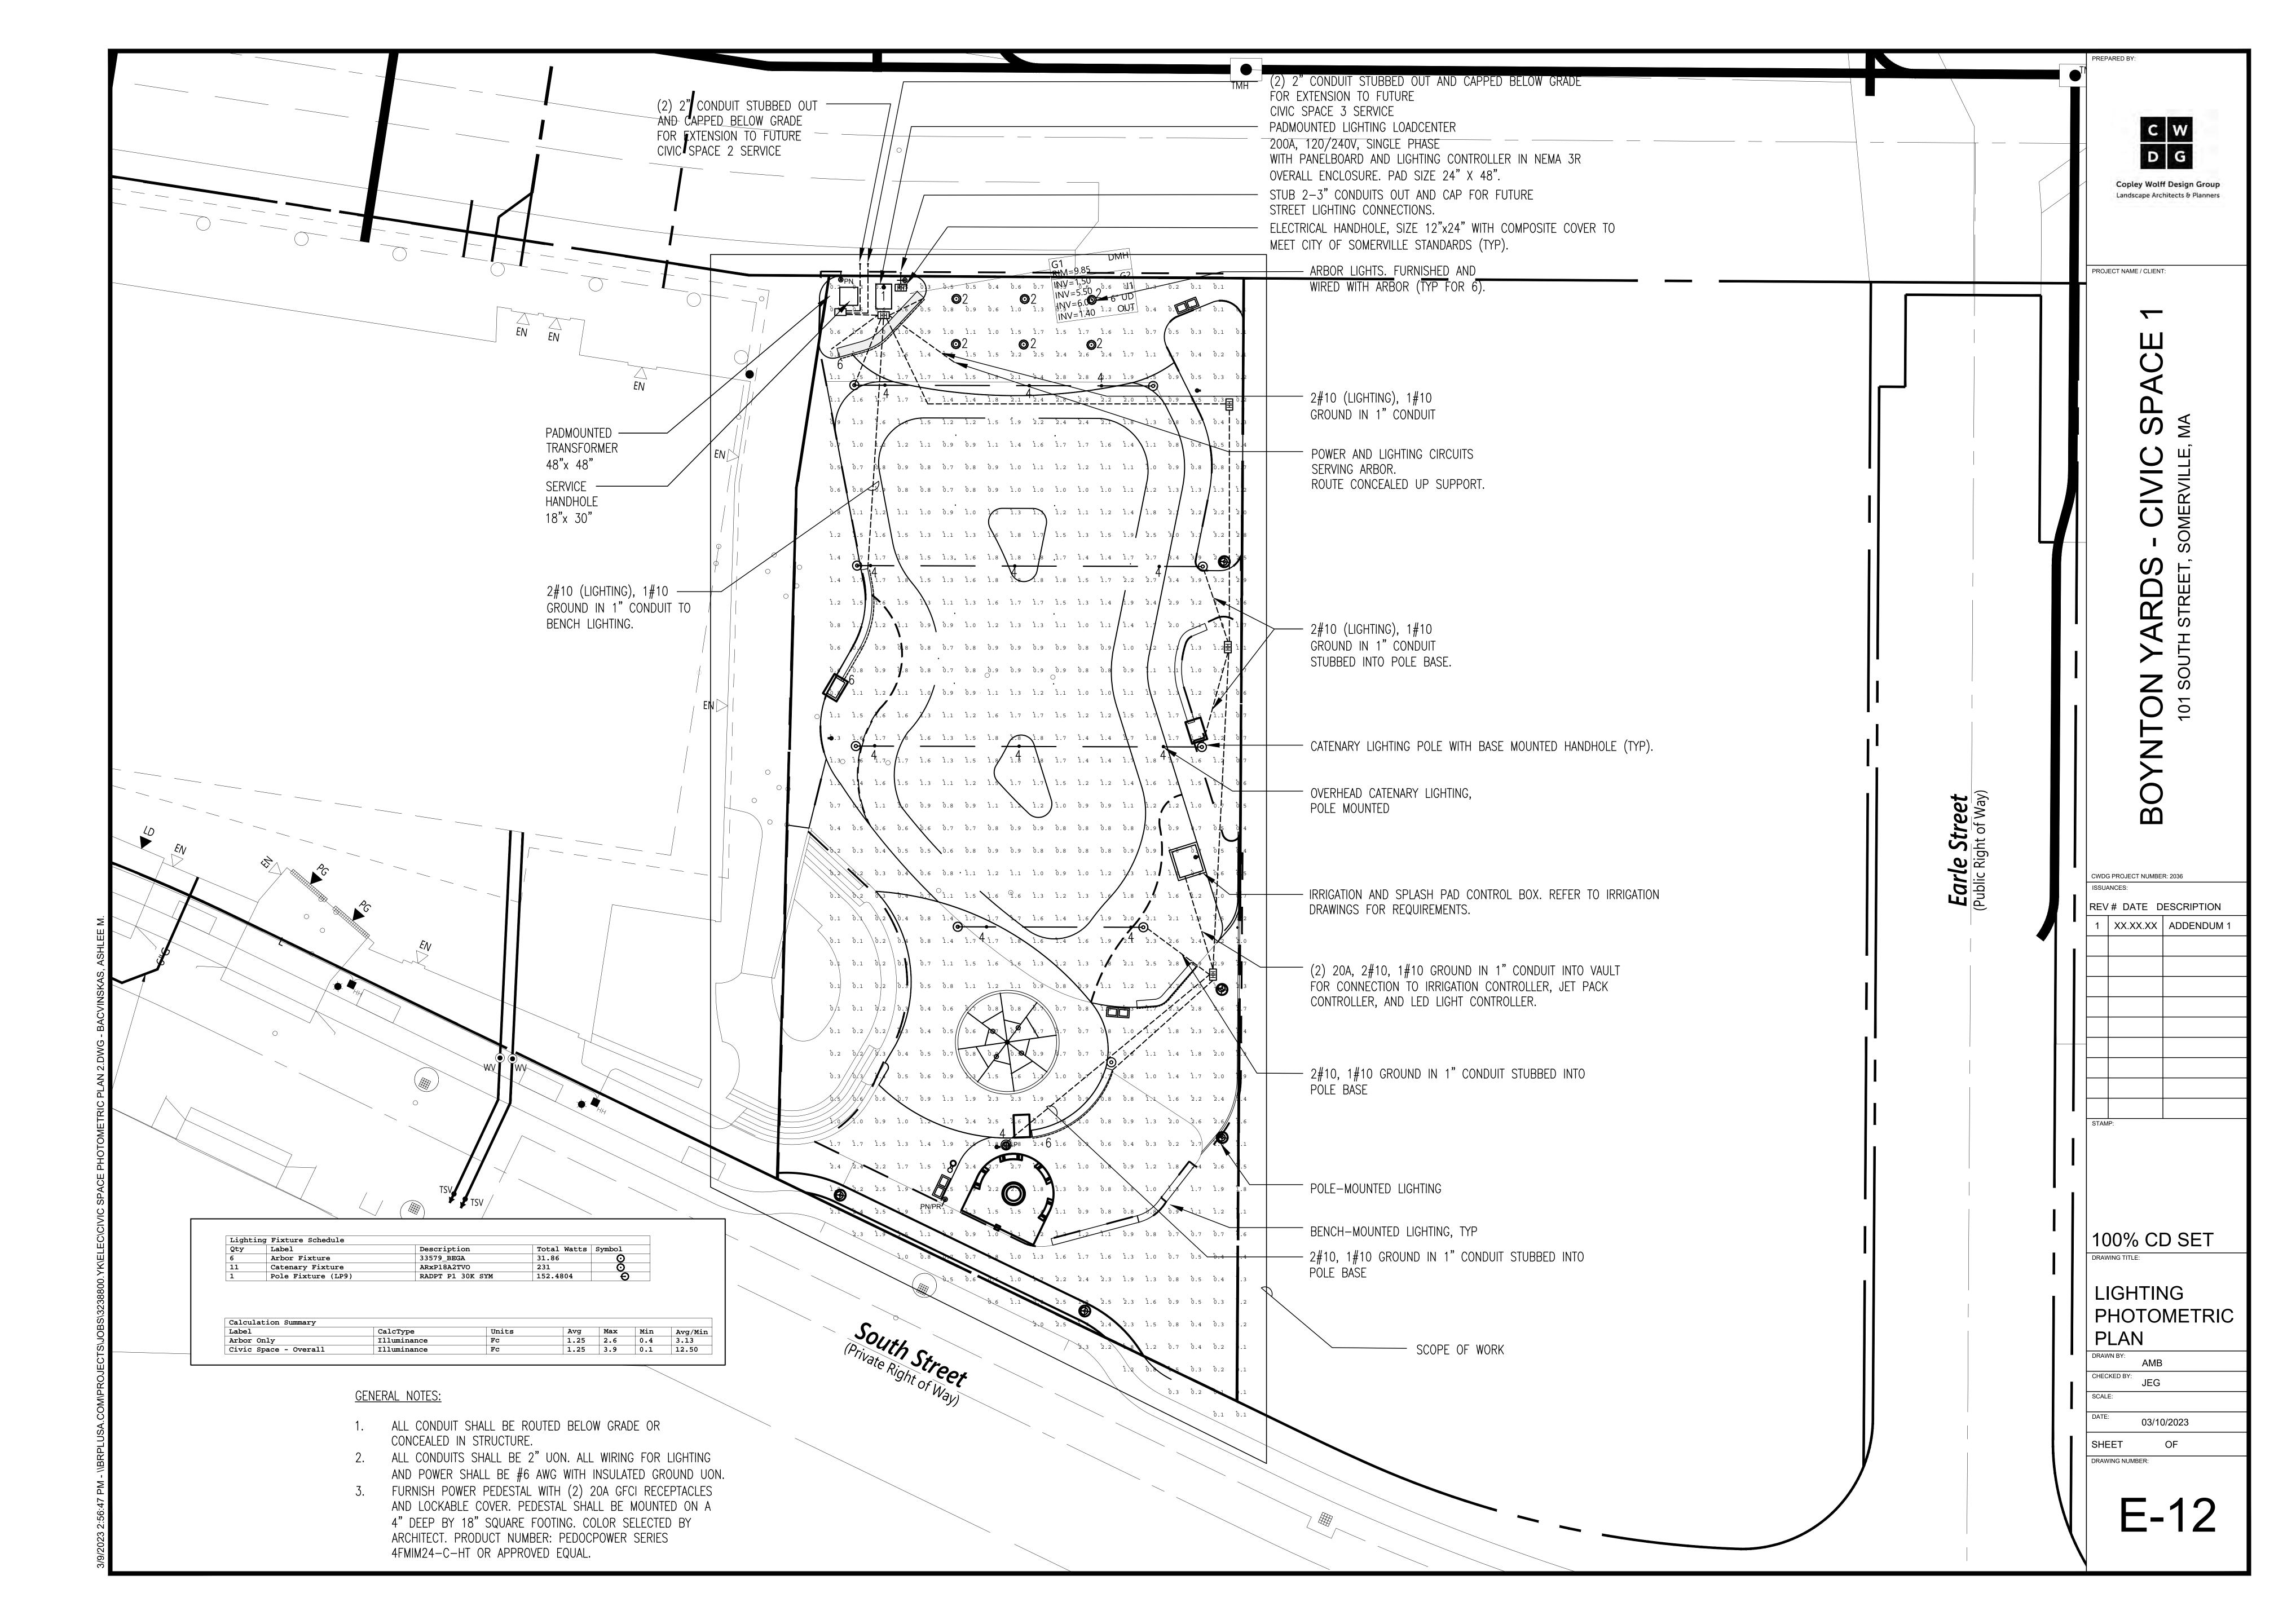
DATE: 3.10.23


SHEET 10 OF 10

DRAWING NUMBER:

IR-10



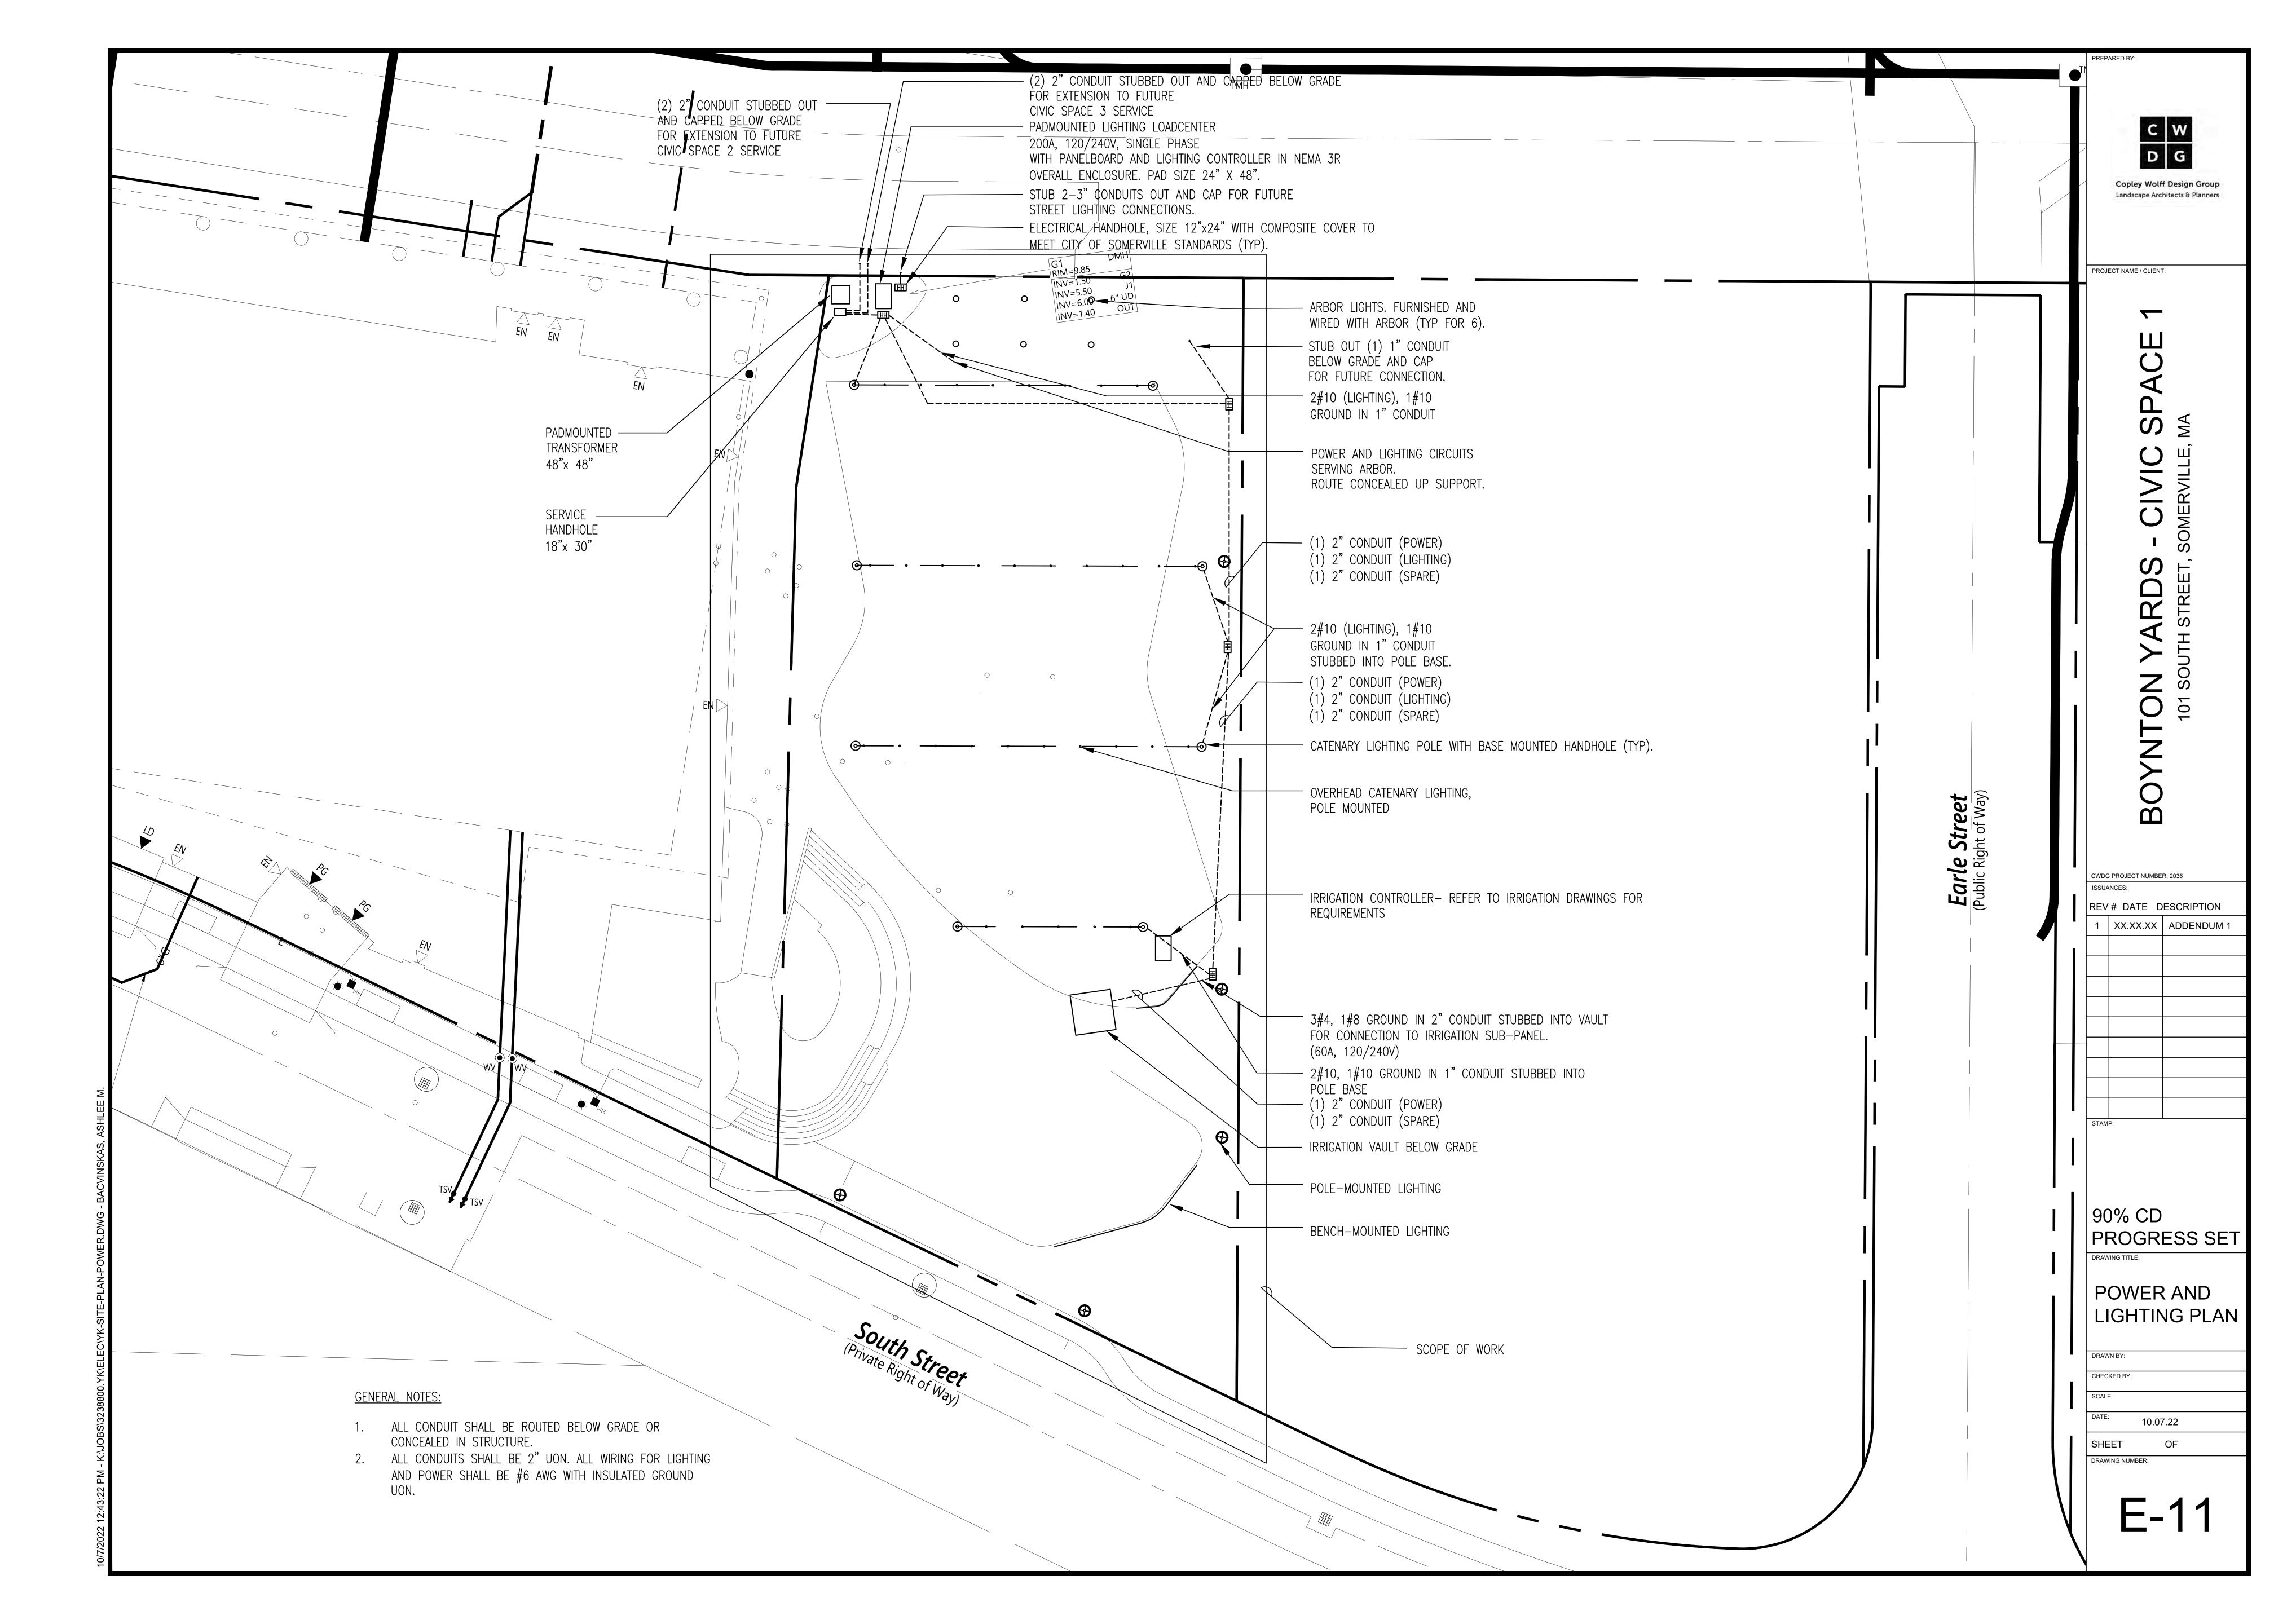

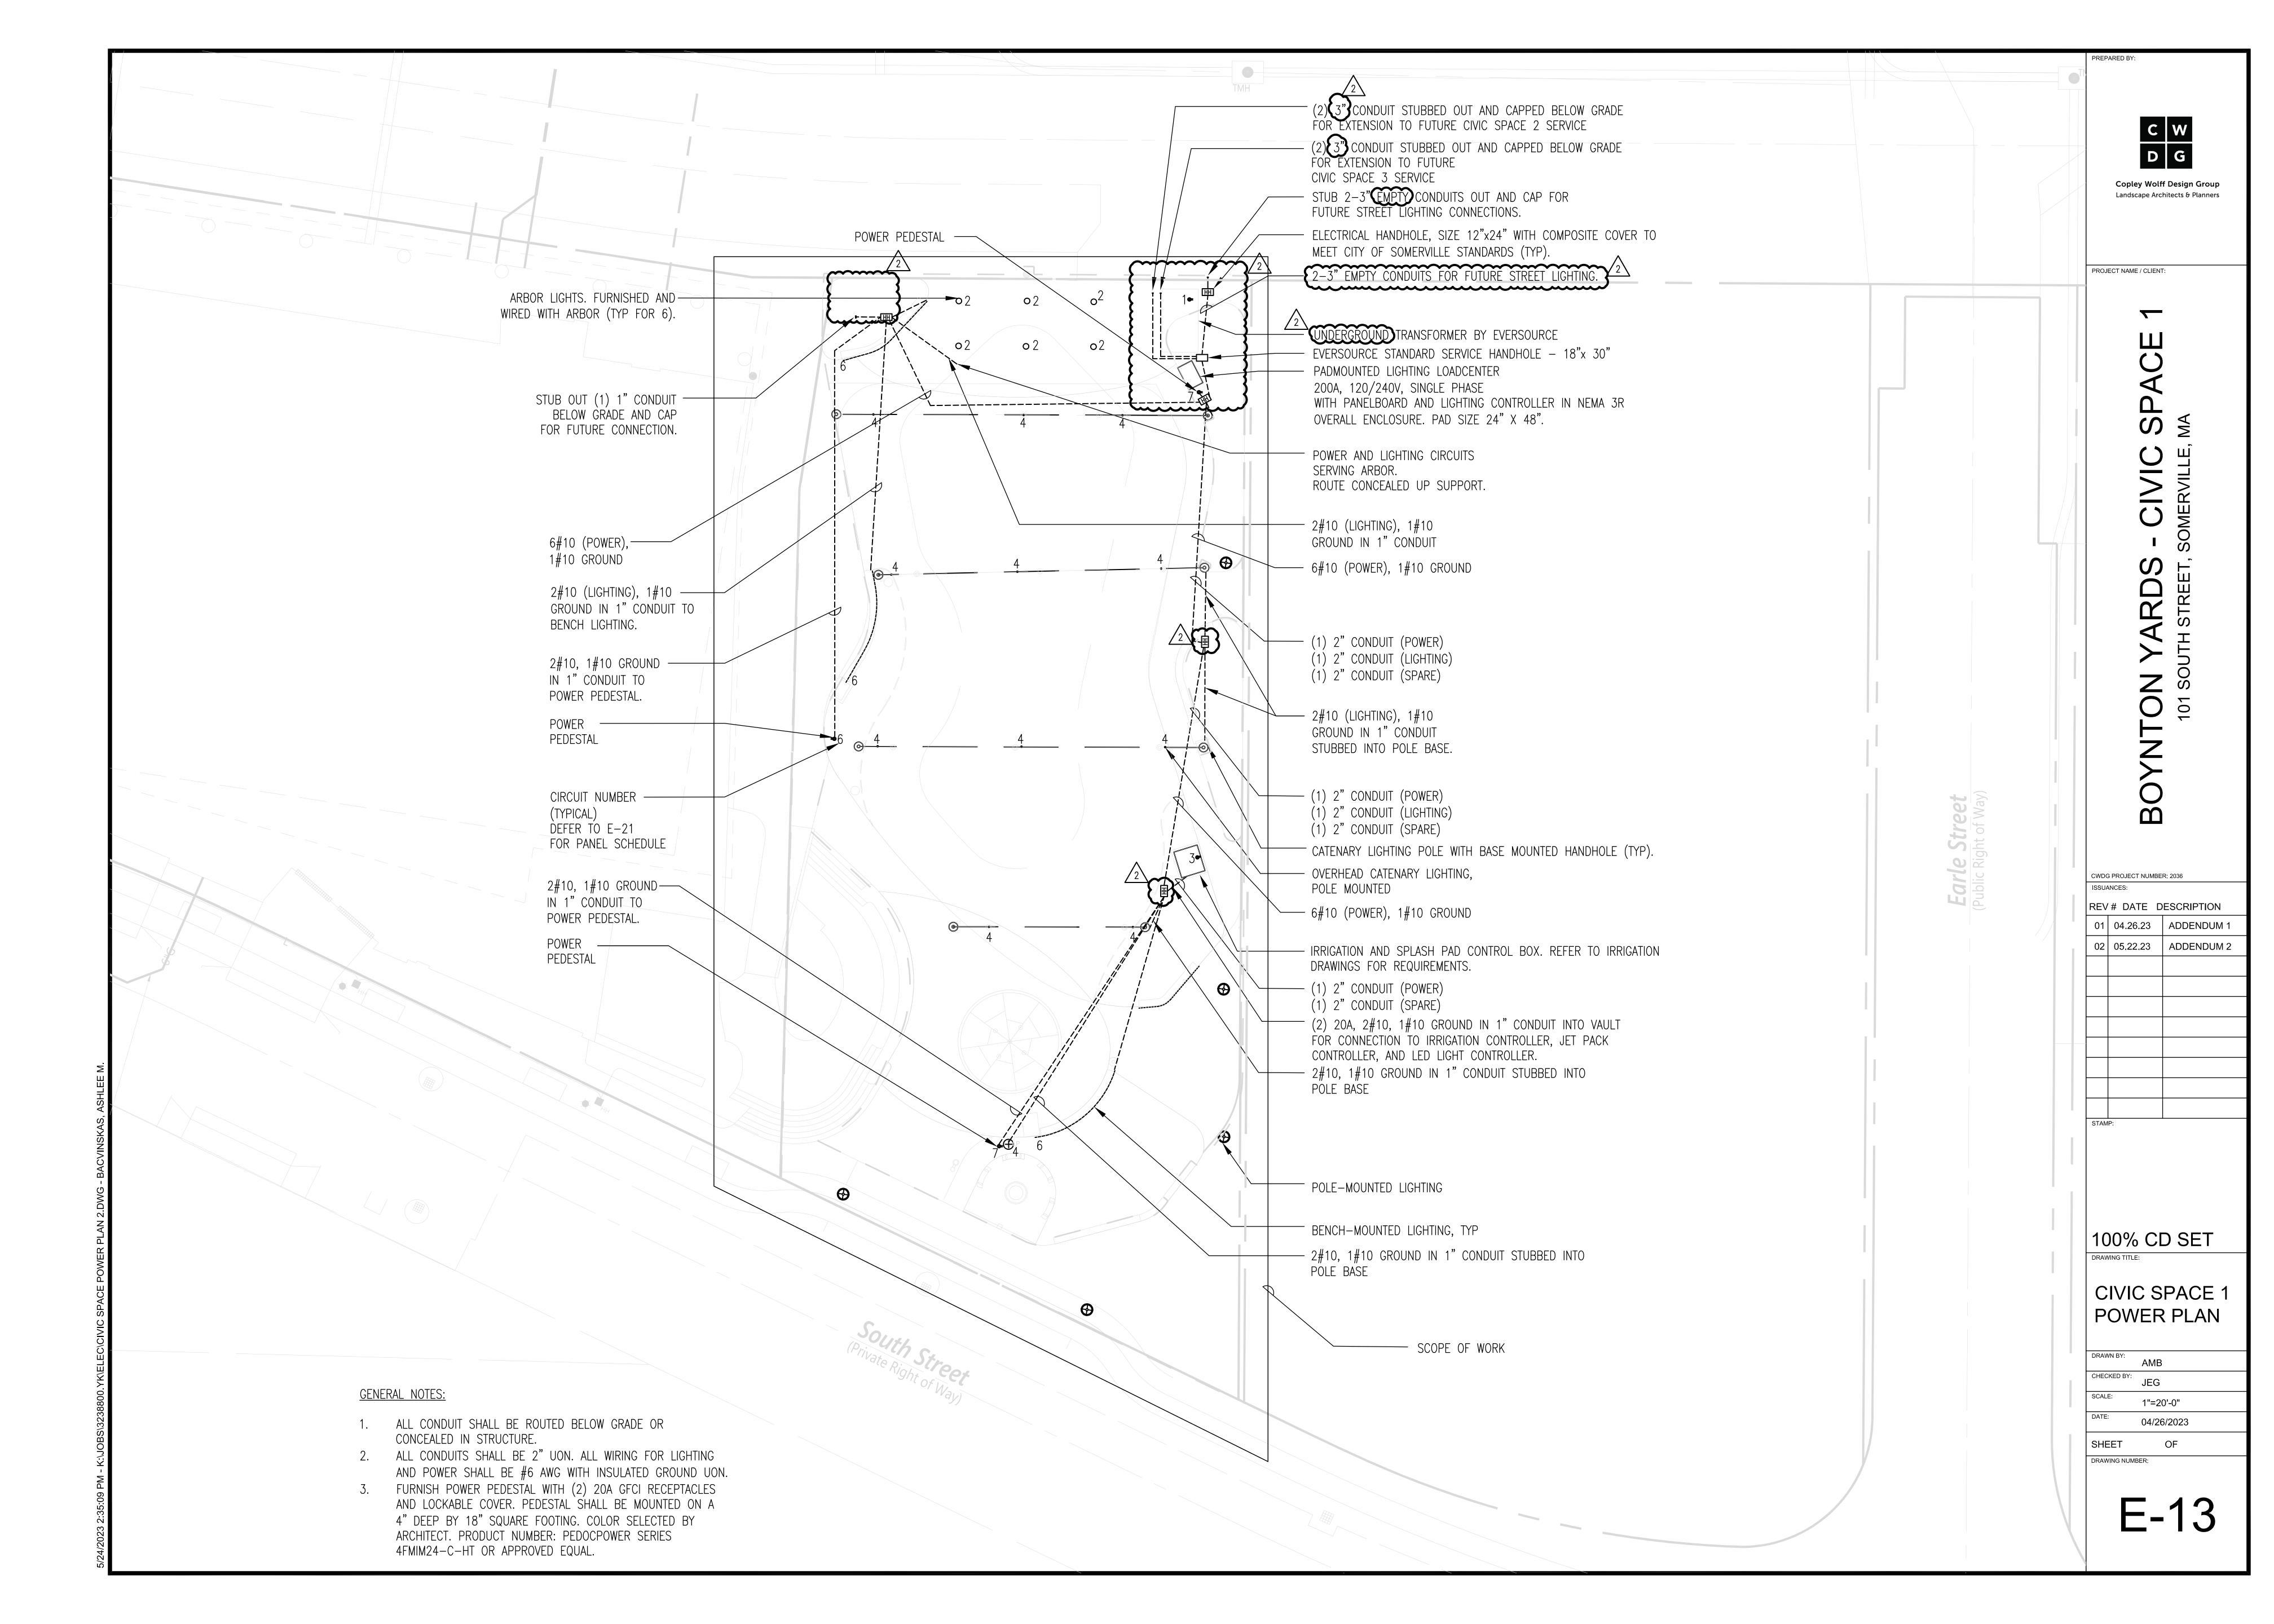

ELECTRICAL

DETAILS

SCALE: NTS

DATE: 04/26/2023

AWING NUMBER:

NOTES:

1. Material: 9. 125 6052-H32 Aluminum

2. NEMA Type: 3R Rating

3. Ventilation on roof and door.

4. Open bottom.

5. Stainless steel full-length plano hinge.
6. Single door design with captive door restraint and Contain lock.
7. Stainless steel padiockable handle, 3-point latching mechanism with nylon rolless at top and bottom.
8. Door frame double flanged on all four sides.
9. 3/4" Plywood back panel treated with clear polyurethans.
10. Cabinet powder coated black.
11. U.L. Listed

MASS GESTRICA, APPARATION TO BEEC TO

#### PADMOUNTED LIGHTING LOADCENTER ENCLOSURE DETAIL

Lighting Fixture Schedule					
Qty	Label	Description	Total Watts		
6	Arbor Fixture	33579 BEGA	31.86		
11	Catenary Fixture	ARxP18A2TVO	231		
1	Pole Fixture (LP9)	RADPT P1 30K SYM	152.5		

R LIGHTING LOAD CENTER REC 200 1 1 20	PR	ROJECT:	NAME BOYNTON YARDS CIVIC				PROJECT #:		32388			<b>ENGIN</b>	ΞER:		XXX				
MAIN BUS: NOTE: AIC: 22K  WATTS LOAD  WATTS LOAD  UT 1	ľ	VOLTAGE: 120 /	240					3 WIRE			TOTAL WATTS L1			43	32	DESIGNA	TION	XXXXXXX	
NOTE: AIC: 22K	Ī	MAIN BREAKER: 200A			FRAME:	RAME:		TRIP:			TOTAL WATTS L3			1,300				1 OF 1 TUBS	
National		MAIN BUS:			MOUNTING:											LOCATIO	N:	LIGHTING LOAD CENTER	
WATTS LOAD	4	NOTE: AIC: 22K									_	VATTS		3,1	116				
DIRECTORY   L1   L2   L3   DIRECTORY			WATTS LOAD		)AD										1	MATTS LOA	\ <b>\</b> D		
R IRRIGATION CENTER REC	LOAD	DIRECTORY				CKT.	AMPS						AMPS	CKT.				DIRECTORY	
R IRRIGATION CENTER REC	R	LIGHTING LOAD CENTER REC	200			1	20		•				20	2	32			ARBOR LTG	=
R POLE-MOUNTED REC 200 7 20	₹	IRRIGATION CENTER REC		1,000		3	20			•			20	4		384		CATENARY LTG	
S SPARE         9         20         0         10         SPARE           S SPARE         11         20         0         12         SPARE           S SPARE         13         20         0         14         SPARE           S SPARE         15         20         0         16         SPARE           S SPARE         17         20         0         18         SPARE           S SPARE         19         20         0         18         SPARE           S SPARE         19         20         0         20         20         SPARE           S SPACE         21         0         0         22         SPACE         SPACE           S SPACE         23         0         0         24         SPACE         SPACE           S SPACE         25         0         0         28         SPACE         SPACE	2	IRRIGATION CENTER REC			1,000	5	20				•		20	6			300	BENCH LTG	•
S SPARE         11         20         20         12         SPARE           S SPARE         13         20         20         14         SPARE           S SPARE         15         20         20         16         SPARE           S SPARE         17         20         20         18         SPARE           S SPARE         19         20         20         20         SPARE           S SPACE         21         22         SPACE           S SPACE         23         24         SPACE           S SPACE         25         26         SPACE           S SPACE         27         28         SPACE	₹	POLE-MOUNTED REC	200			7	20	<b></b>	•				20	8				SPARE	•
SPARE 13 20	s	SPARE				9	20			•			20	10				SPARE	
S SPARE 15 20	s	SPARE				11	20				•		20	12				SPARE	
S SPARE         17         20         20         18         SPARE           S SPARE         19         20         20         20         SPARE           SPACE         21         0         22         SPACE           SPACE         23         0         24         SPACE           SPACE         25         0         26         SPACE           SPACE         27         0         28         SPACE	s	SPARE				13	20	<b>」</b> _⌒_	•				20	14				SPARE	
S SPARE         19         20         20         20         20         SPARE           SPACE         21         0         0         22         SPACE         SPACE           SPACE         23         0         0         24         SPACE         SPACE           SPACE         25         0         0         26         SPACE         SPACE           SPACE         27         0         0         28         SPACE	s	SPARE				15	20			•			20	16				SPARE	
SPACE         21         22         SPACE           SPACE         23         24         SPACE           SPACE         25         26         SPACE           SPACE         27         28         SPACE	s	SPARE				17	20					<u> </u>	20	18				SPARE	
SPACE         23         C         24         SPACE           SPACE         25         C         26         SPACE           SPACE         27         C         28         SPACE	s	SPARE				19	20		•				20	20				SPARE	
SPACE         25         C         26         SPACE           SPACE         27         C         28         SPACE		SPACE				21		<b></b>		•				22				SPACE	_
SPACE         27         28         SPACE		SPACE				23					•			24				SPACE	_
		SPACE				25		<b></b>	•					26				SPACE	
SPACE 29		SPACE				27				•				28				SPACE	_
SUBTOTAL         400         1,000         1,000         SUBTOTAL	$\perp$					29		<u></u>			•			30				SPACE SUBTOTA	_

